


PHOTOMONTAGE 1 – CORNER OF KING GEORGES ROAD AND STONEY CREEK ROAD



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DRAWING: PHOTOMONTAGE

| -| drawing no. | jl, db | DA - 1900

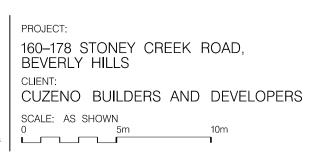



PHOTOMONTAGE 2 - CORNER OF STONEY CREEK ROAD AND LEE AVENUE





DATE: 15 MAR 2017 CHECKED 1: FM CHECKED 2: DRAWN BY: DRAWING No. JL, DB DA - 1901

PHOTOMONTAGE 2 DRAWING:

JOB N ISSUE A

05 VIEW FROM 1 LEE AVENUE TOWARD SUBJECT SITE

IMAGES 01–05 GOOGLE 2016




04 EXISTING TRAFFIC CALMING DEVICE AND TREES



03 EXISTING COMMERCIAL PREMISES TO BE DEMOLISHED





02 intersection of king george's road and stoney creek road

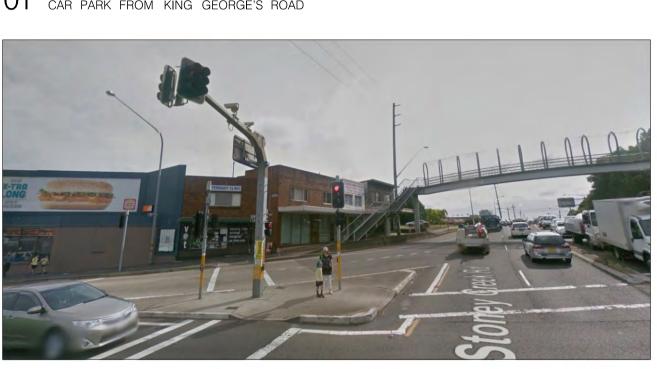

01 VIEW TO REAR LANE AND EXISTING CAR PARK FROM KING GEORGE'S ROAD



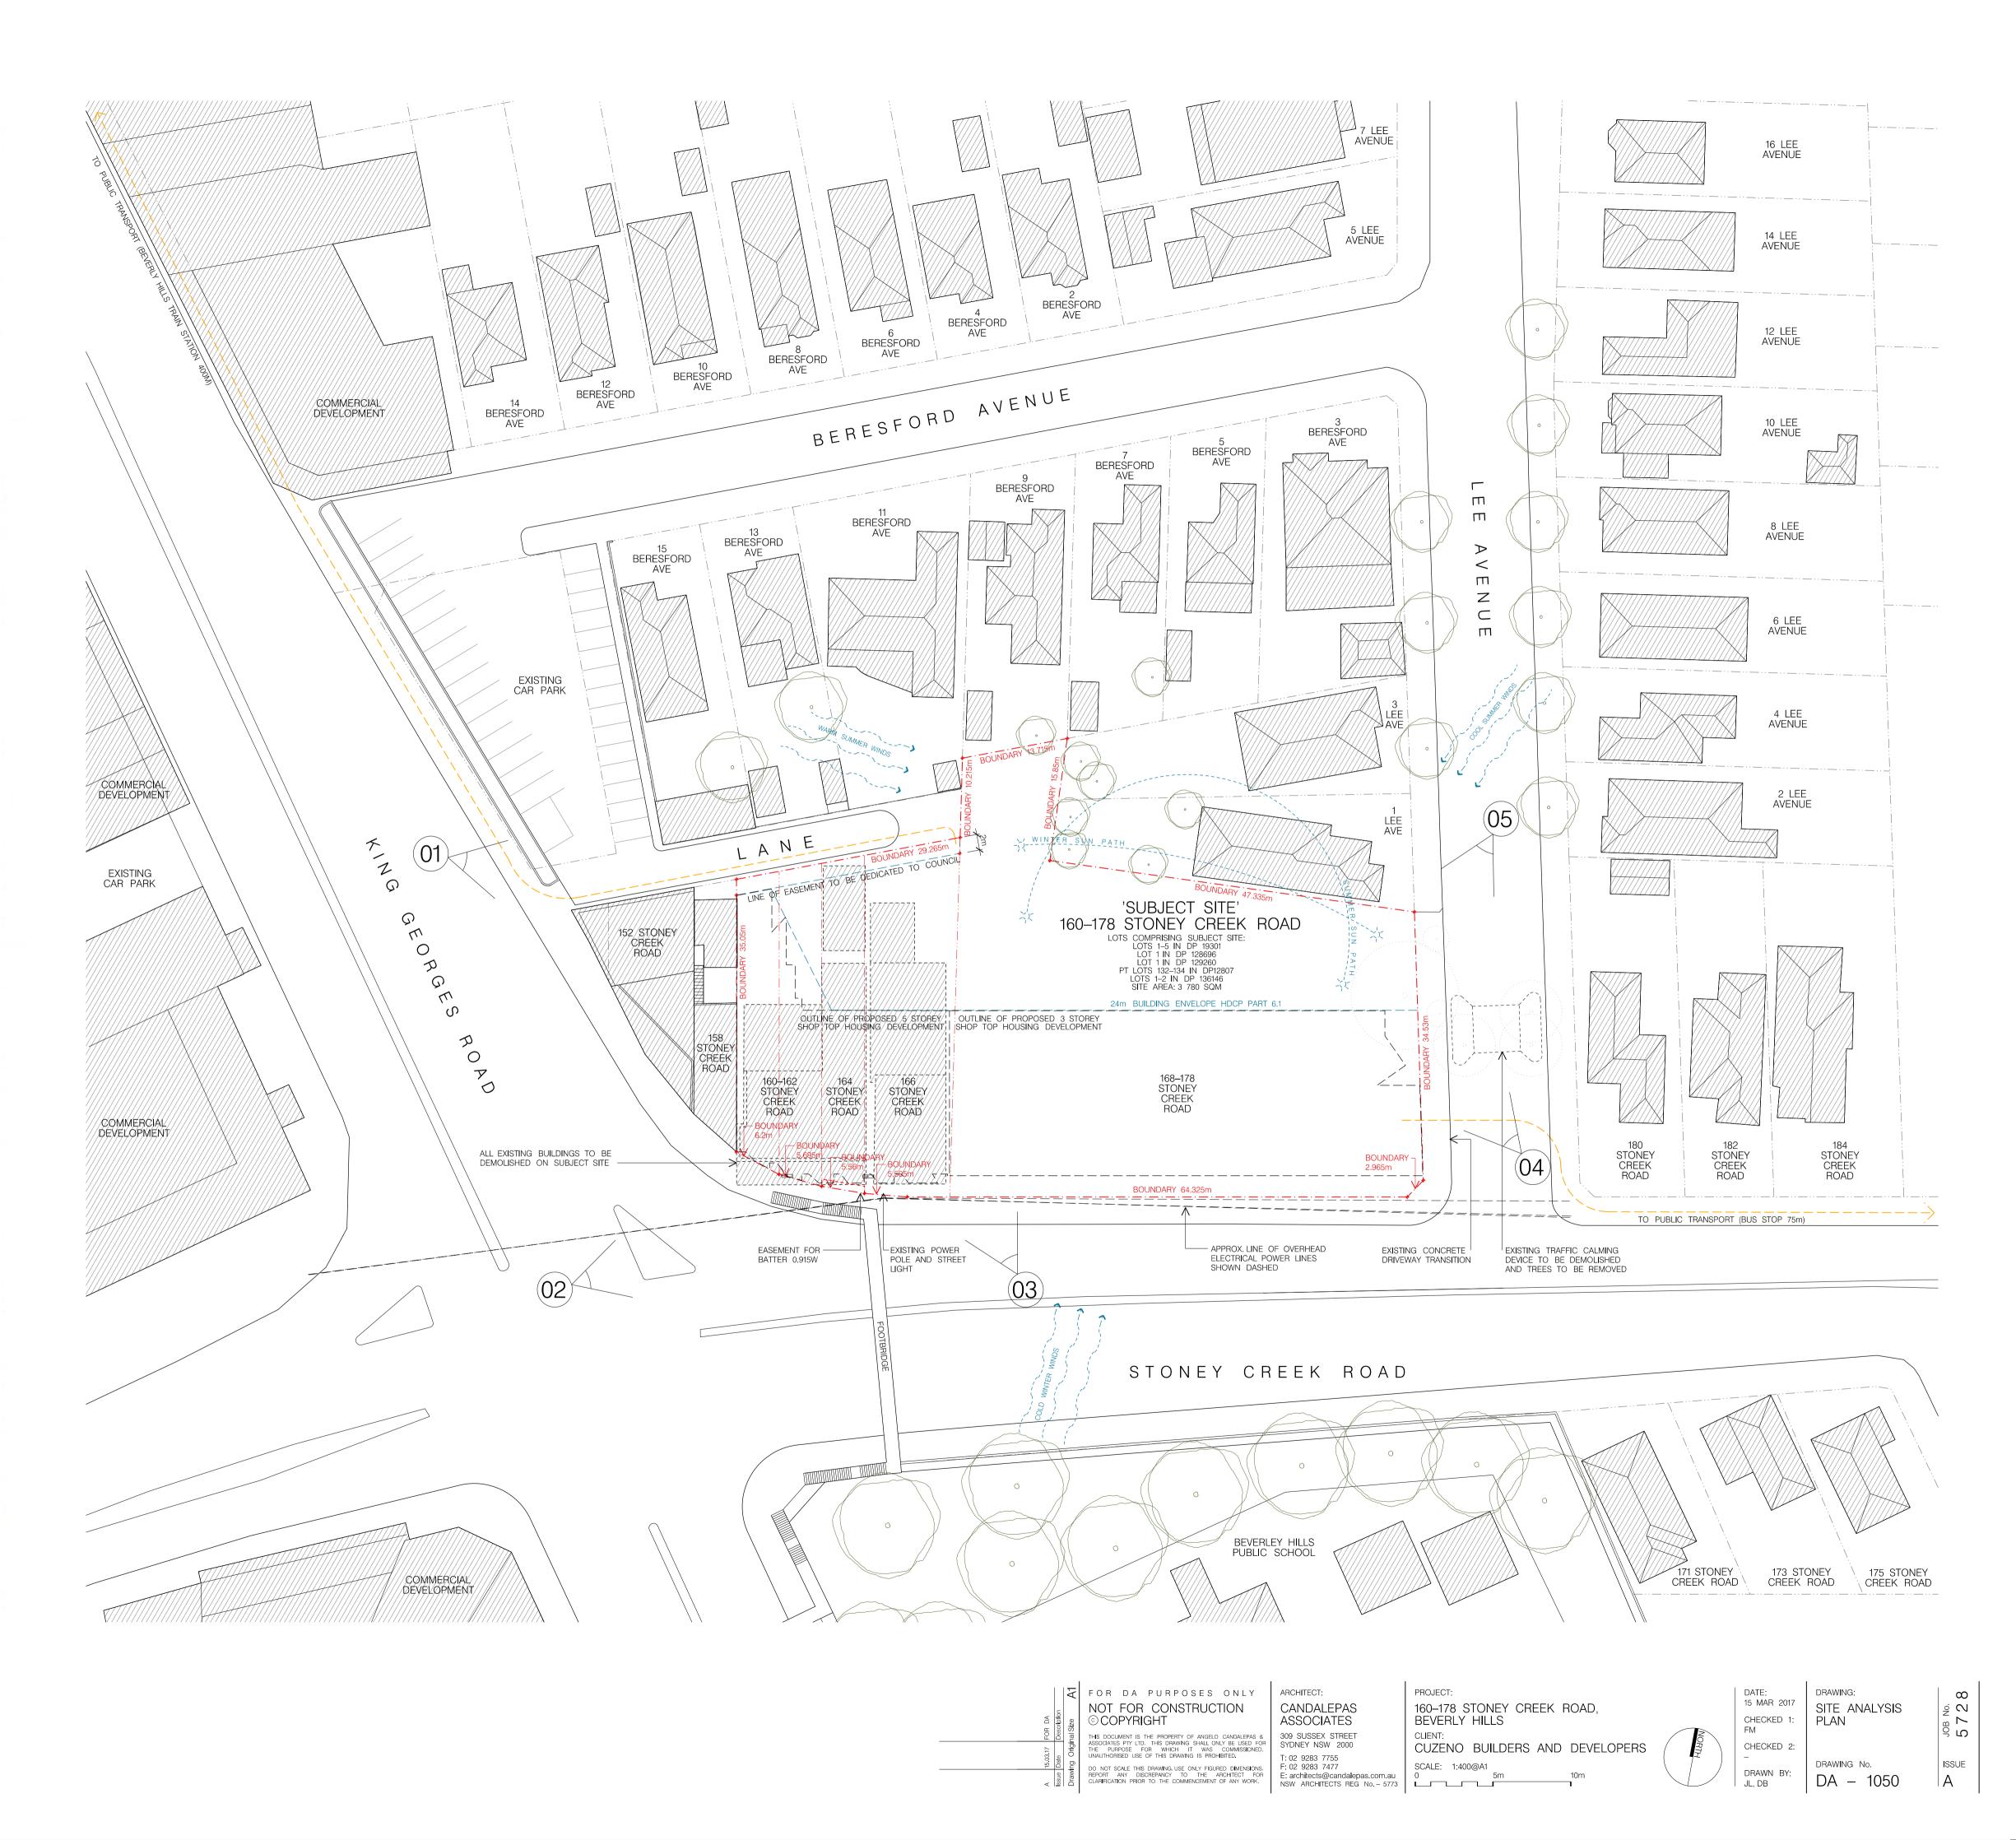

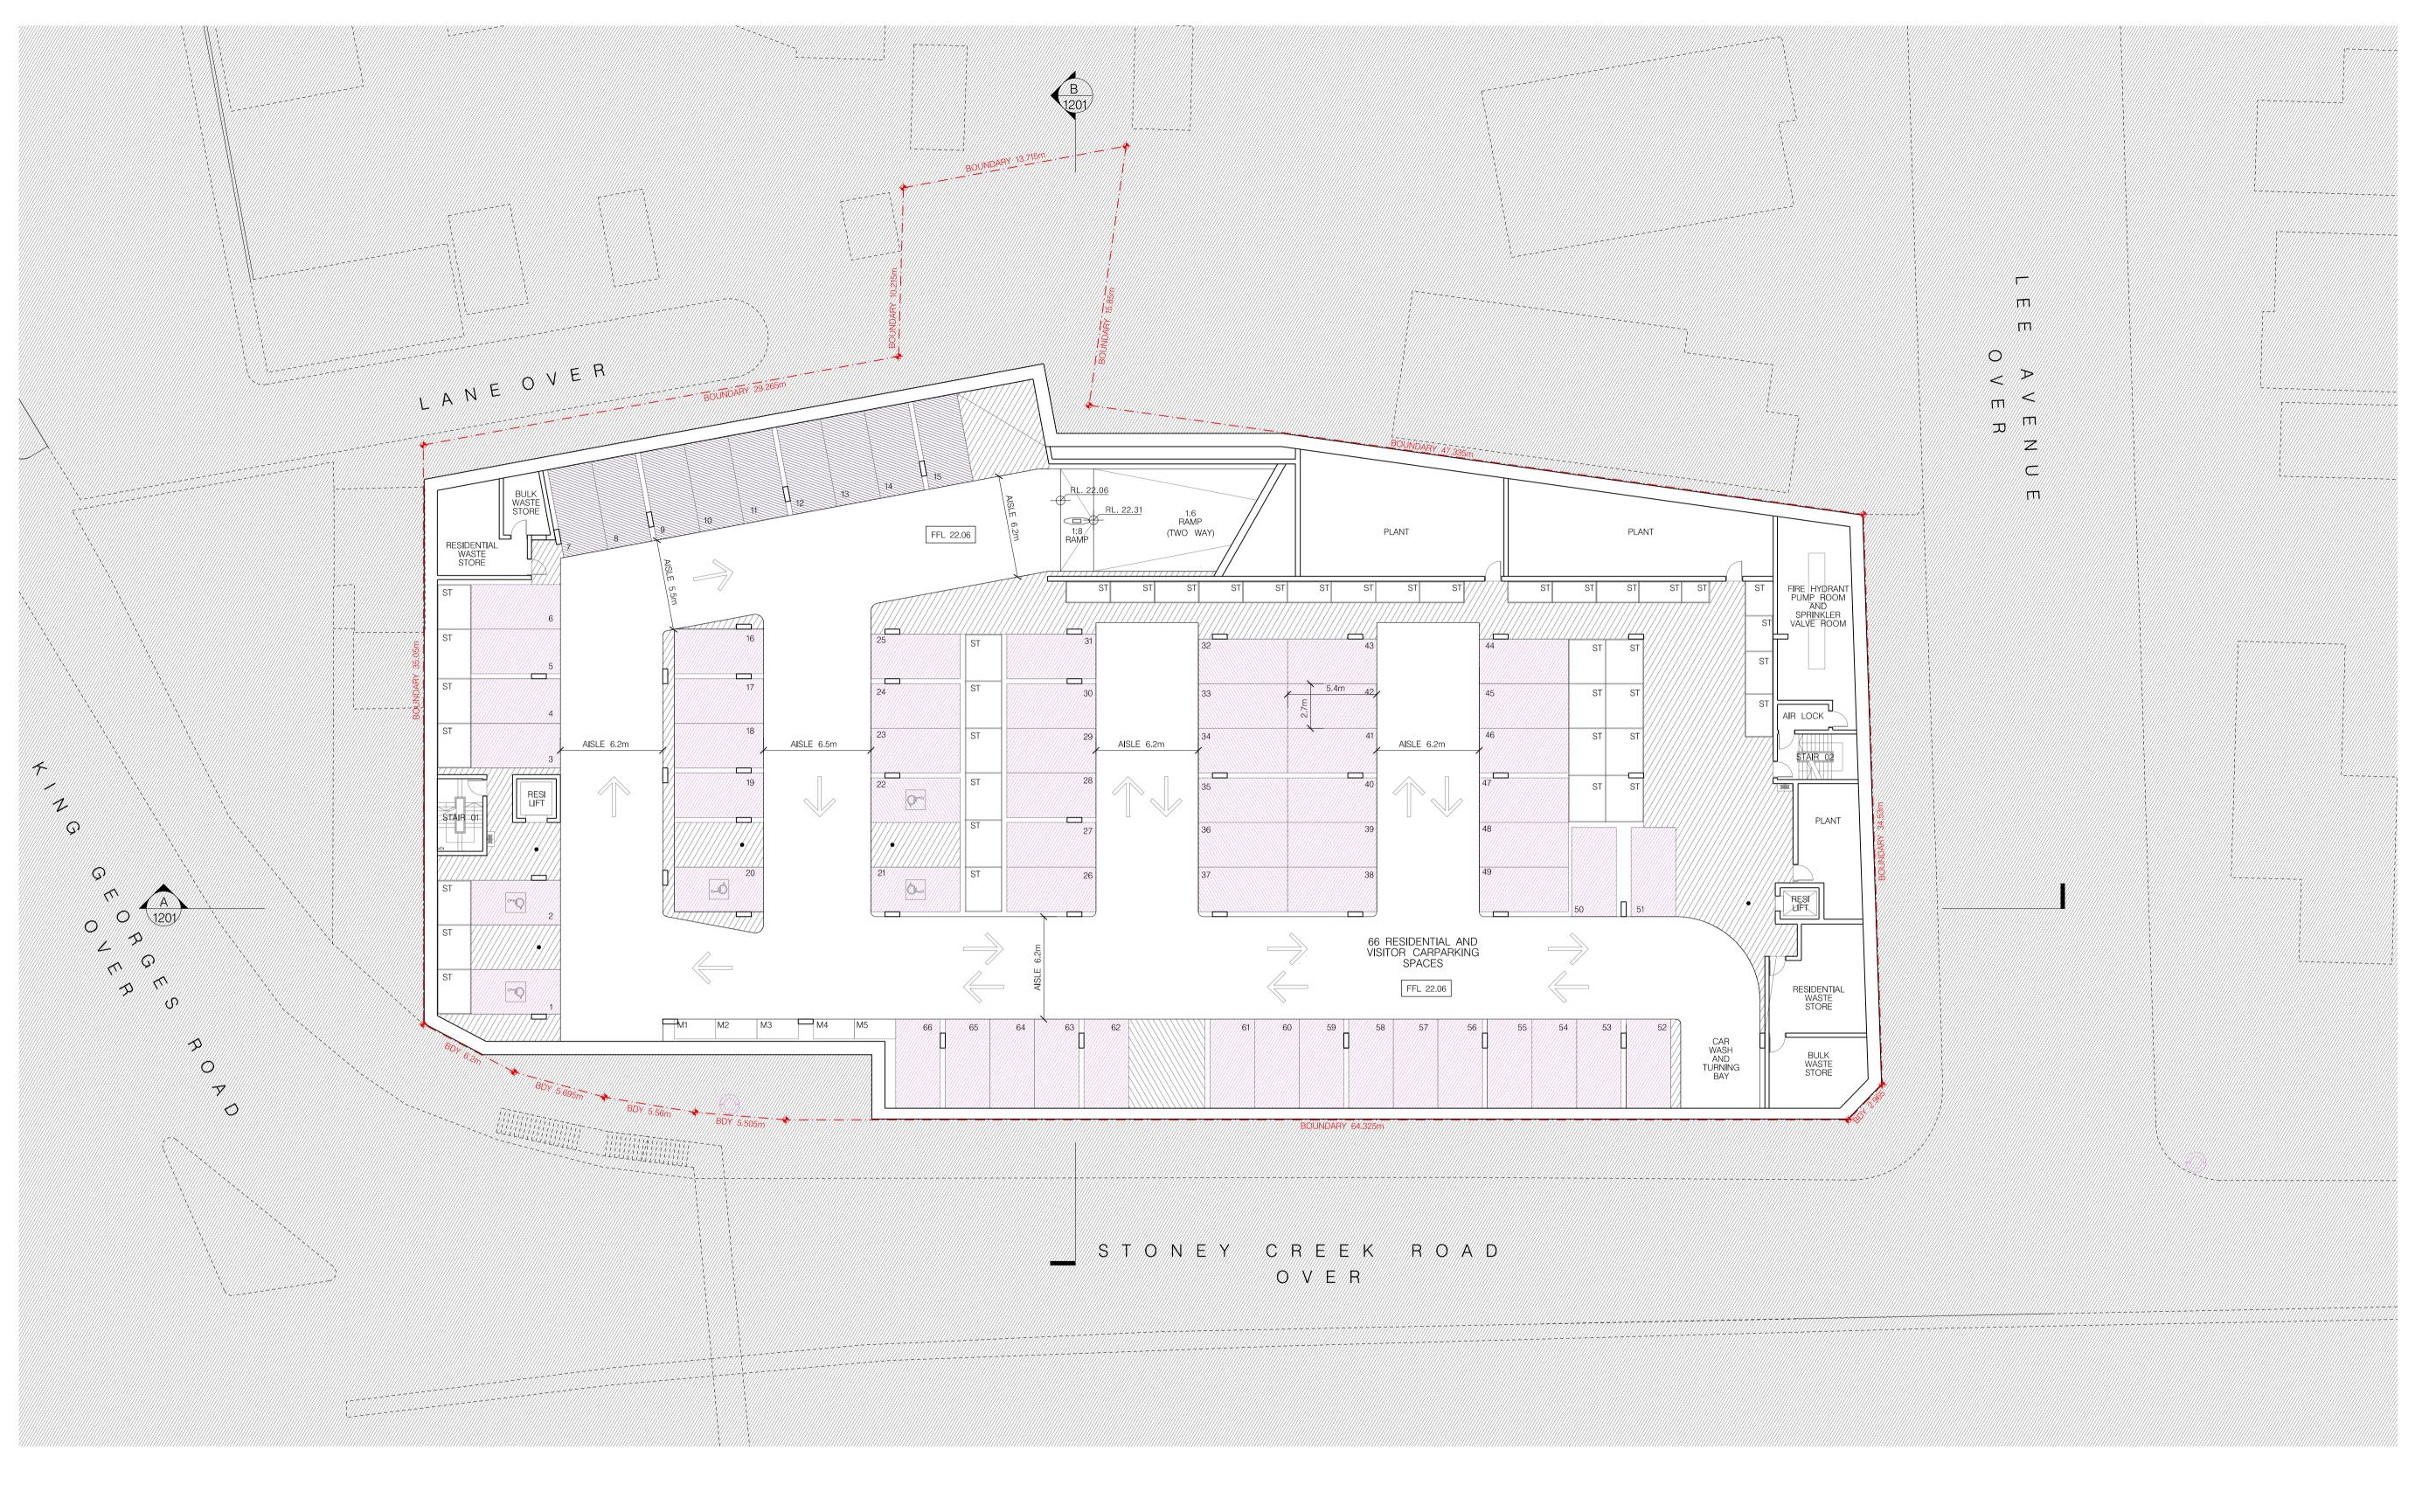


BASEMENT LEVEL PLAN B3 ______ 1:200 ___

RETAIL CAR PARKING


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CHECKED 2: - DRAWN BY: JL, DB	drawing no. DA – 1101	issue A




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CANDALEPAS ASSOCIATES 309 SUSSEX STREET SYDNEY NSW 2000

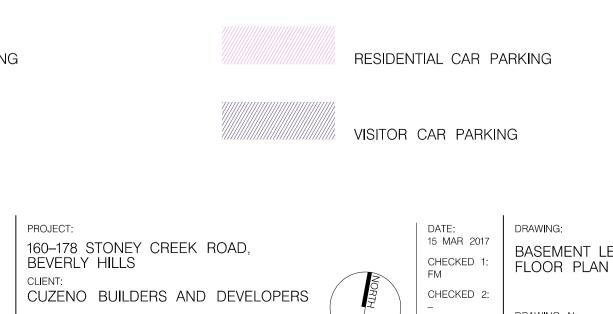VISITOR CAR PARKING DATE:
15 MAR 2017DRAWING: ∞ CHECKED 1:
FMBASEMENT LEVEL 2 $2 \sim$
 \sim
 Γ PROJECT: 160–178 STONEY CREEK ROAD, BEVERLY HILLS CLIENT: CUZENO BUILDERS AND DEVELOPERS NORTH CHECKED 2:

JOB N DRAWN BY: JL, DB DRAWING No. ISSUE A

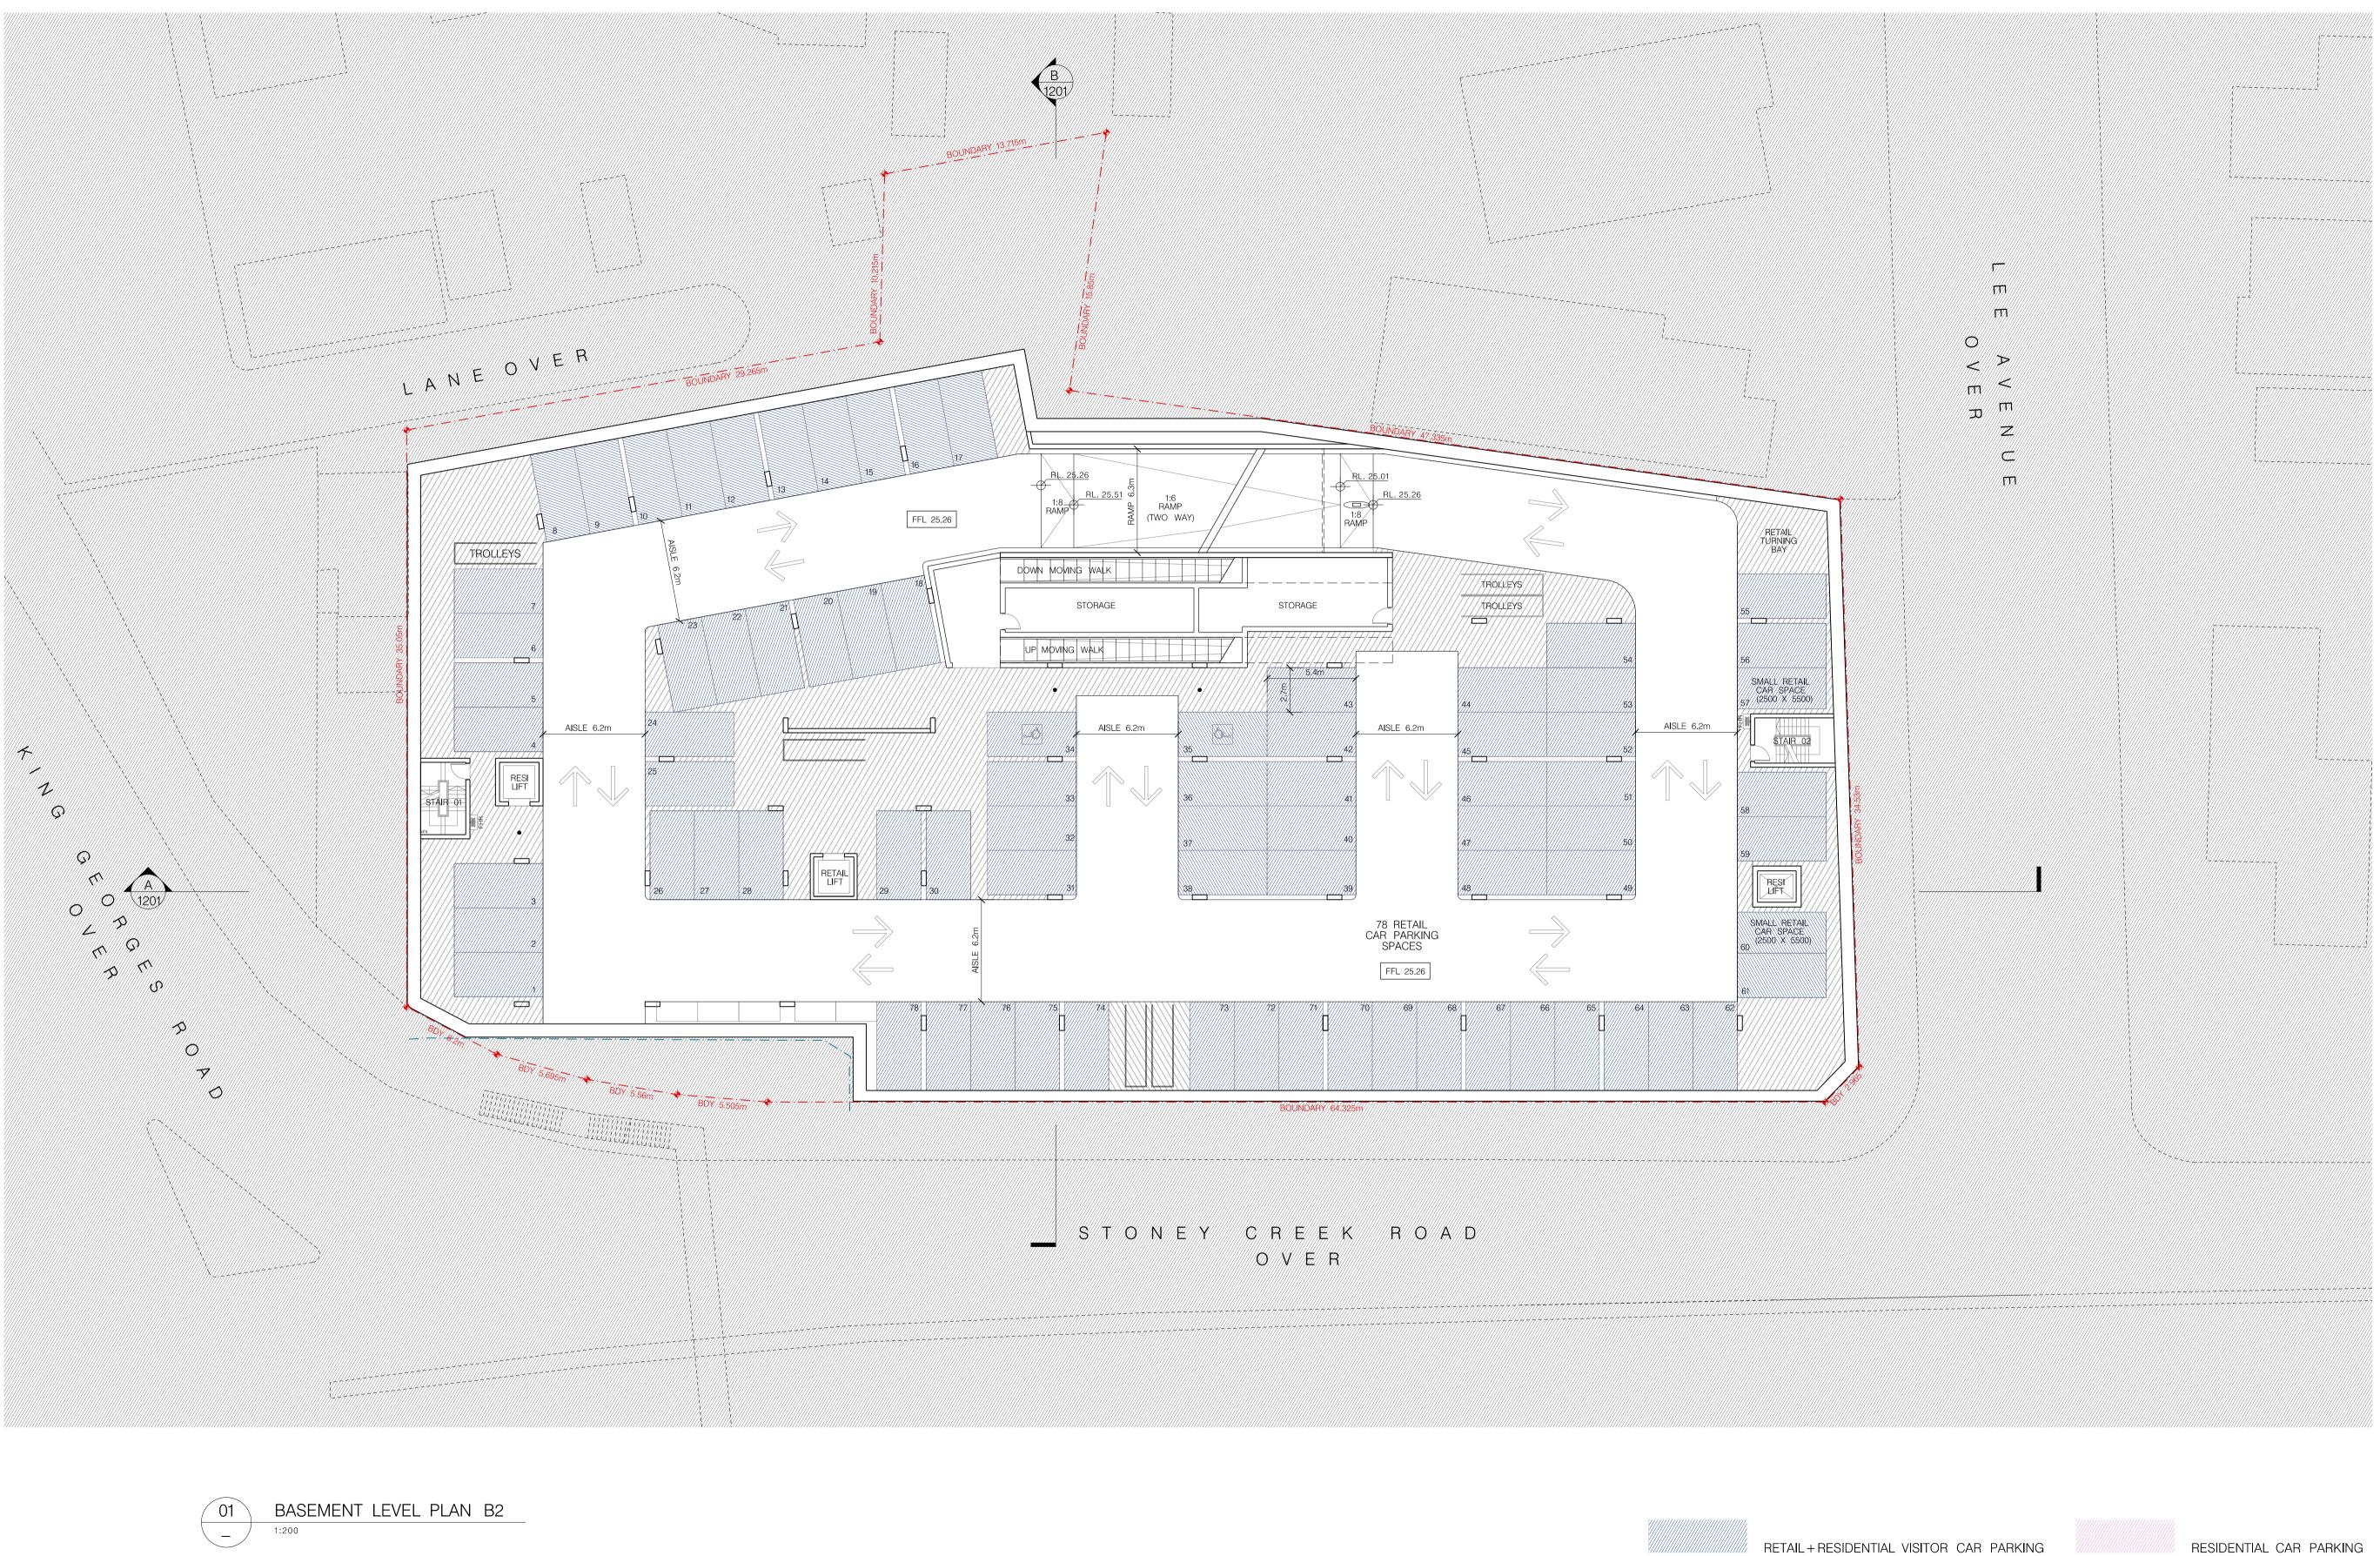

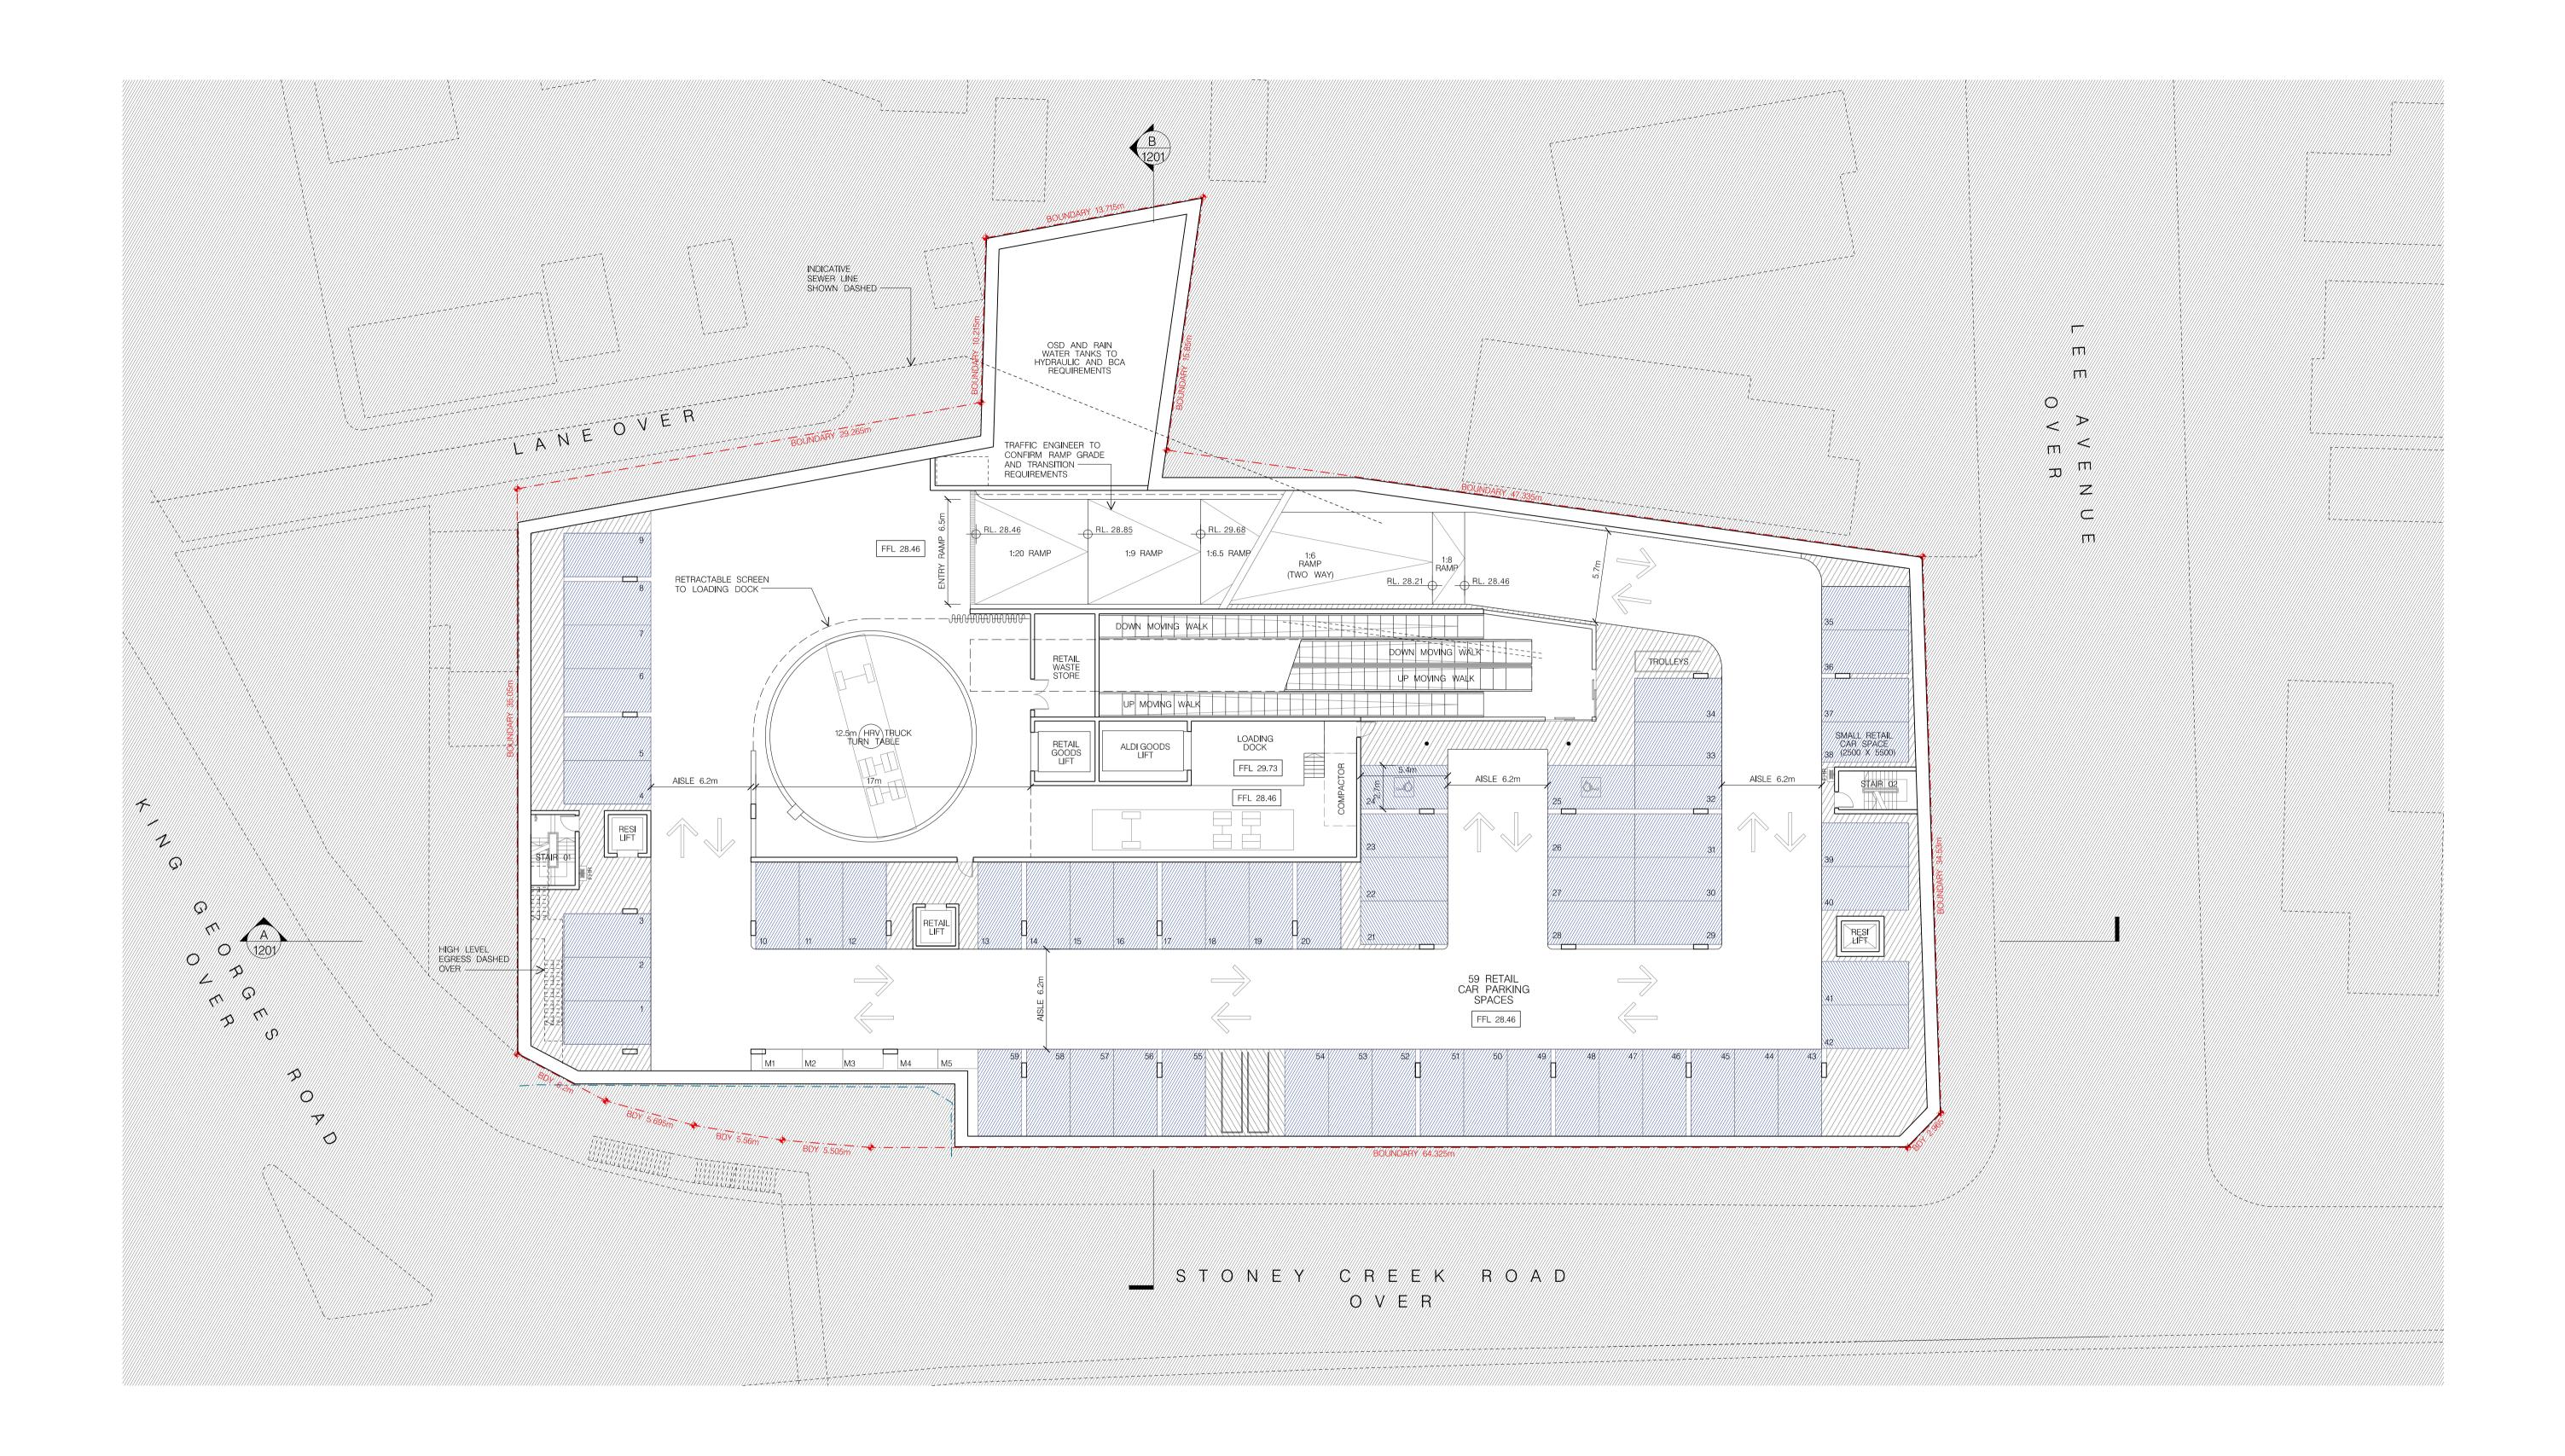

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RETAIL CAR PARKING

RESIDENTIAL CAR PARKING VISITOR CAR PARKING PROJECT:







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DRAWING: CHECKED 1: BASEMENT LEVEL FM PLAN B1

ω JOB No. 572 ISSUE A



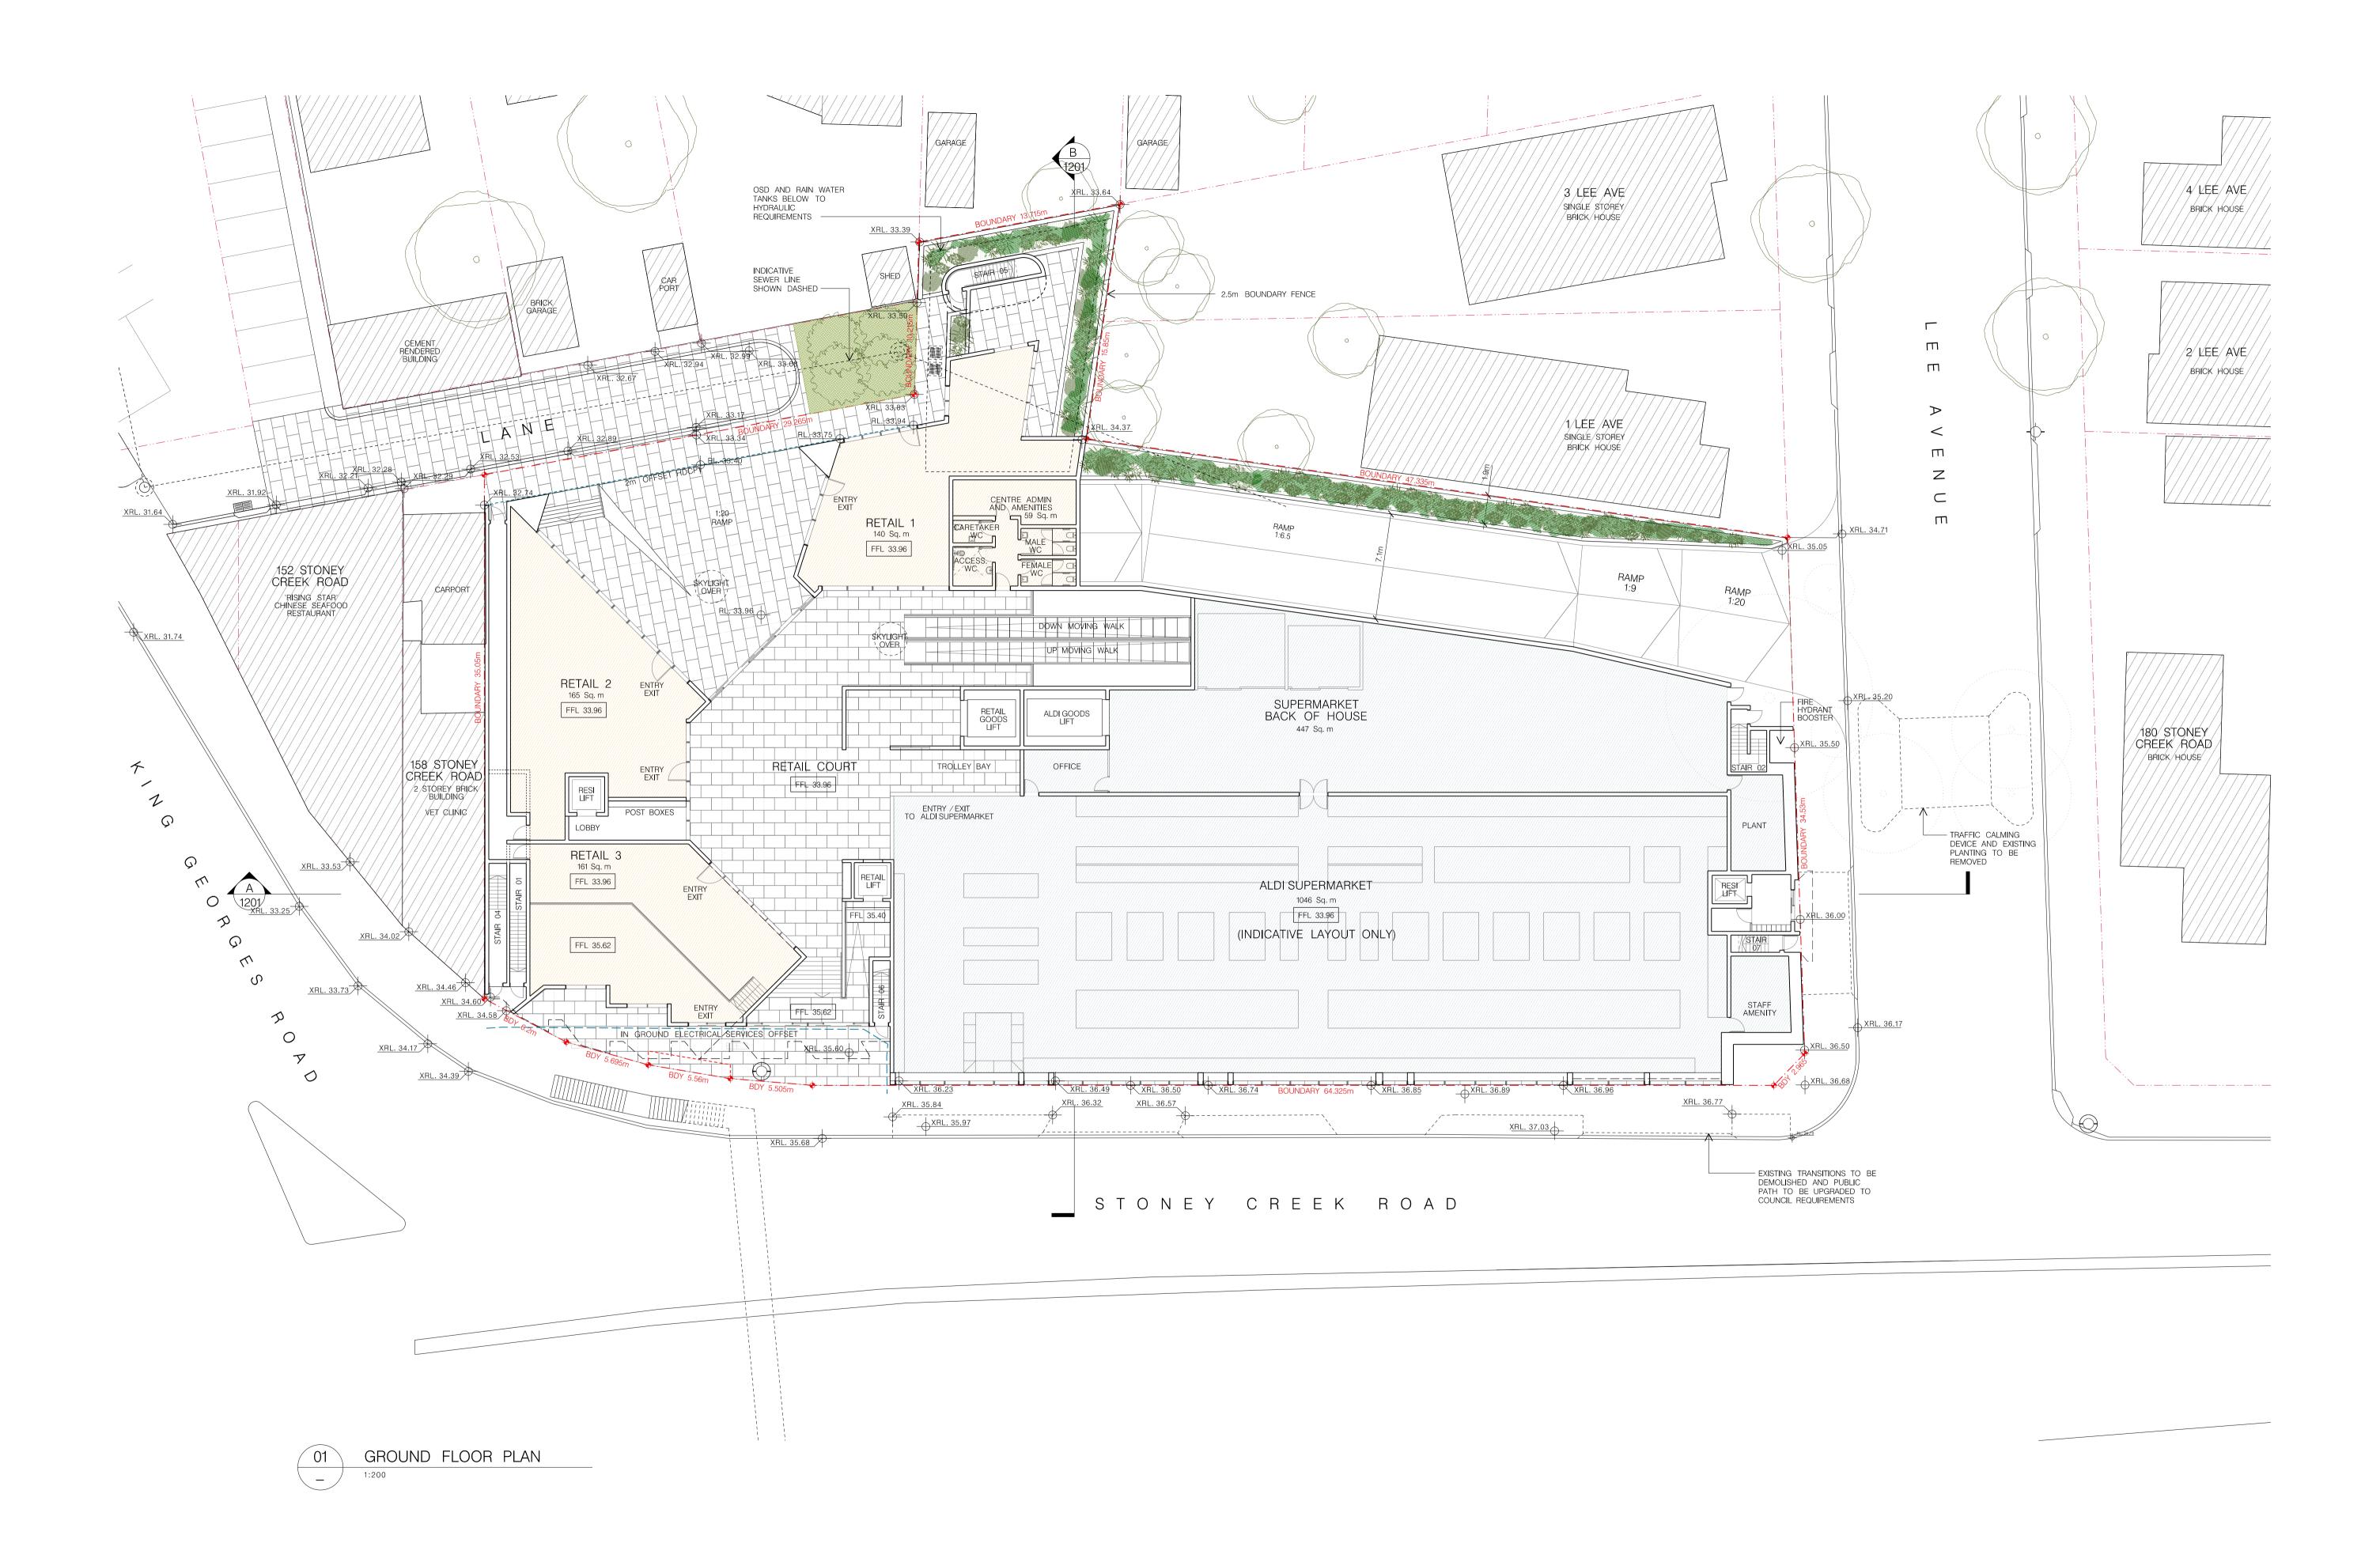
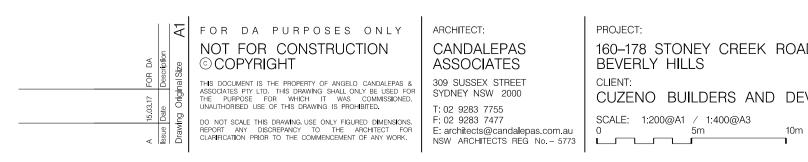
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PROJECT: 160–178 STONEY CREEK ROAD, BEVERLY HILLS CLIENT: CUZENO BUILDERS AND DEVELOPERS



DATE: 15 MAR 2017 CHECKED 1: FLOOR PLAN CHECKED 2: DRAWN BY: JL, DB

DRAWING: GROUND

 ∞ 9 ∾ ISSUE A




01	LE	EVEL	1	FLOOR	PLAN	
	1:2	00				

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DATE: 15 MAR 2017 CHECKED 2: DRAWN BY: JL, DB

DRAWING: CHECKED 1: LEVEL 1 FM FLOOR PLAN 2 8 2 JOB N ISSUE A



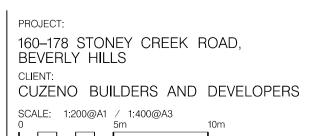

01 LEVEL 2 FLOOR PLAN 1:200 _ _ _

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DRAWING: CHECKED 1: LEVEL 2 FM FM


 ∞ ISSUE A



LEVEL 3 FLOOR PLAN 01 1:200 LEVEL 4 PLAN SIMILAR ____

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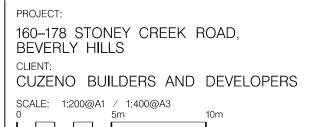


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DRAWING: LEVEL 3 AND 4 FLOOR PLAN 2 8 JOB N ISSUE A

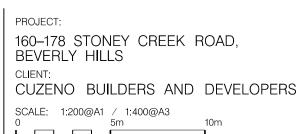








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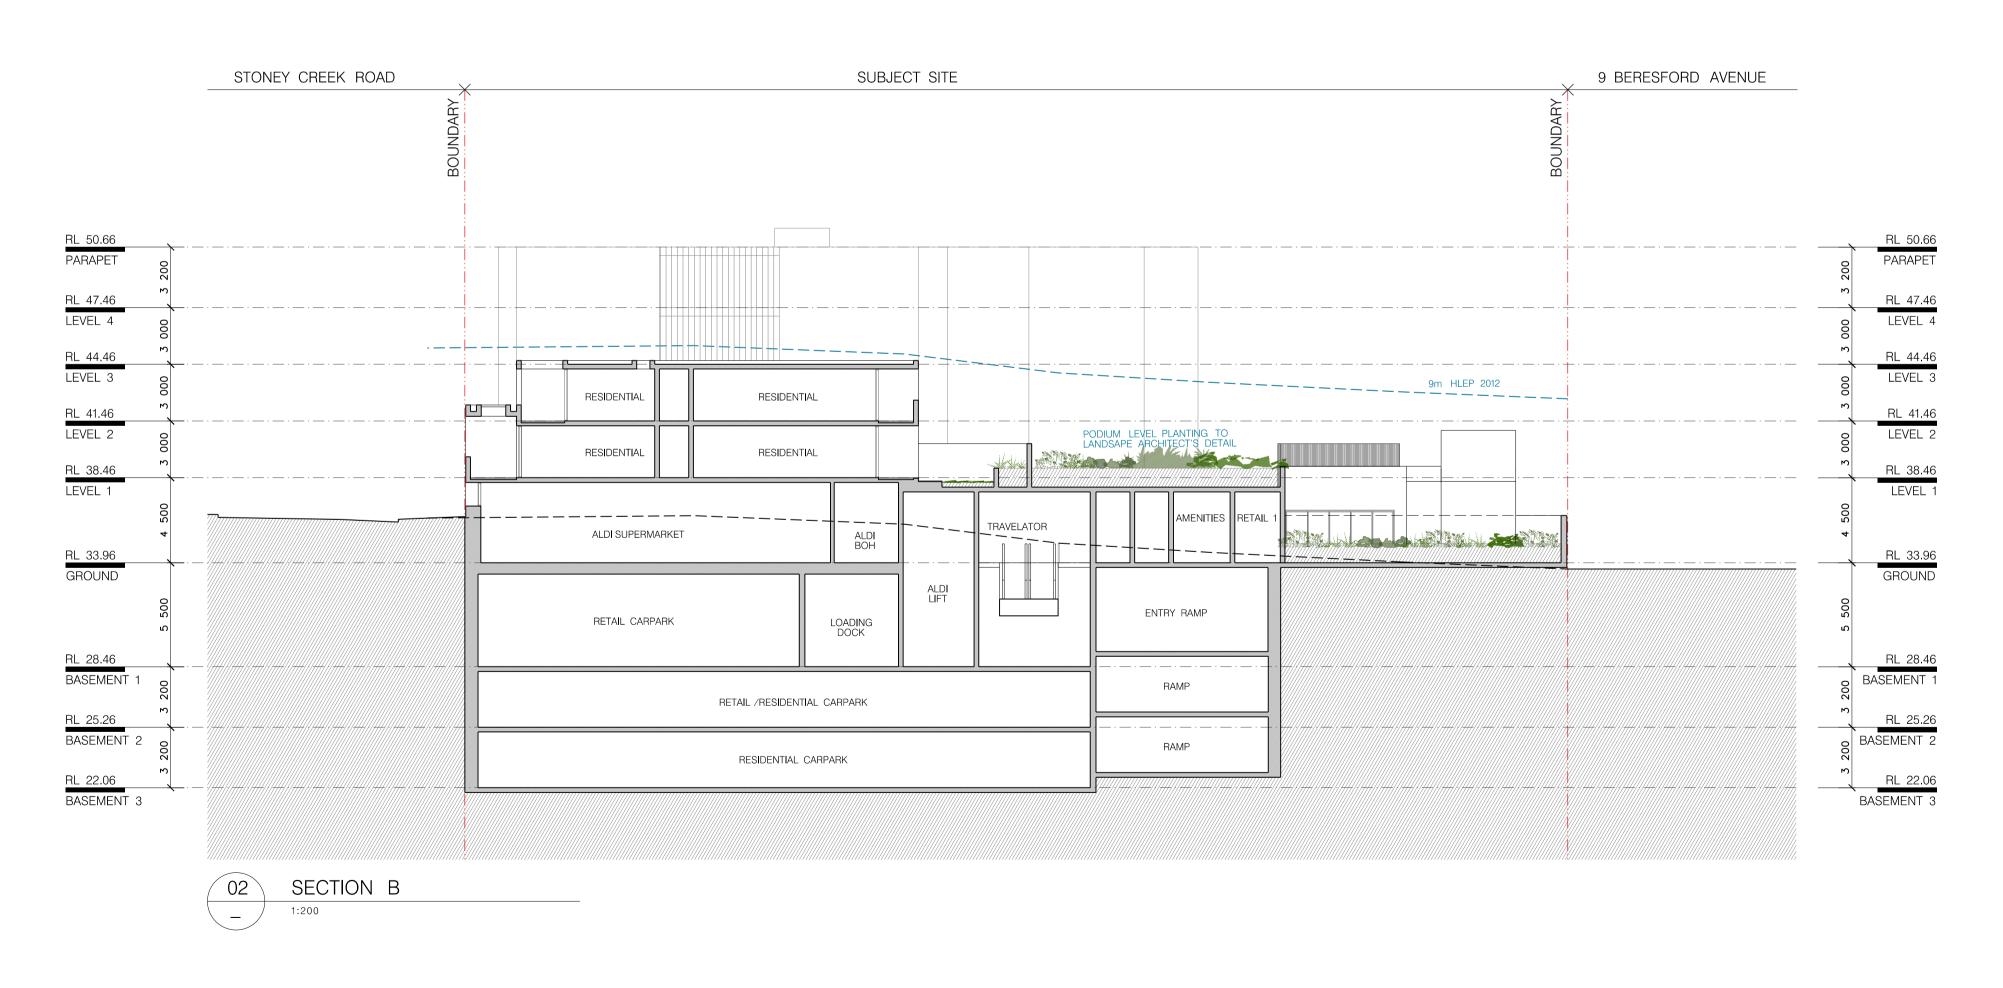
DATE: DRAWING: 15 MAR 2017 ROOF PLAN



KING GEORGES ROAD

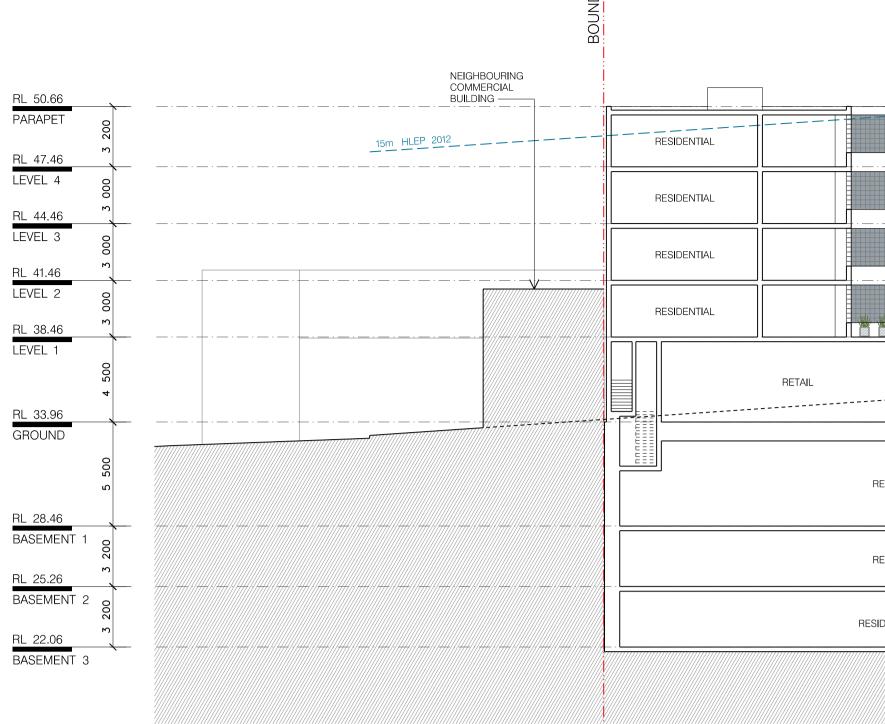


SECTION A 01 1:200 —



							BOUNDARY	
LIGHTWELL	TRAVELATOR — BEYOND SHOWN DASHED	NATURAL GROUND		· · · · · · · · _				RL 50.66 PARAPET RL 47.46 C LEVEL 4
				RESIDENTIAL	LOBBY		9m HLEP 2012	RL 44.46 00 LEVEL 3 00 RL 41.46
			LIGHT	RESIDENTIAL	LOBBY	RESI. LIFT		RL 41.46 00 LEVEL 2 % RL 38.46 LEVEL 1
RETAIL COURT			SUPERMARKET					RL 33.96 GROUND
RETAIL CARPARK			RETAIL CARPARK					85 5 RL 28.46
RETAIL CARPARK			RETAIL CARPARK					BASEMENT 1
ESIDENTIAL. CARPARK	L		RESIDENTIAL. CARPARK					BASEMENT 2 RL 22.06 BASEMENT 3



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PROJECT: 160–178 STONEY CREEK ROAD, BEVERLY HILLS CLIENT: CUZENO BUILDERS AND DEVELOPERS

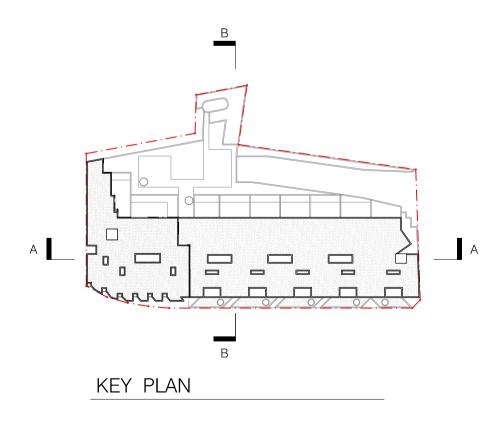DATE: 15 MAR 2017 CHECKED 1: FM CHECKED 2: -DRAWN BY: JL, DB

DRAWING: SECTIONS A & B

DRAWING No.

DA – 1201

ω j ⊂N 1 OB N ISSUE A





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160–178 STONEY CREEK ROAD, BEVERLY HILLS


 Image: Second CUZENO BUILDERS AND DEVELOPERS


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– DRAWN BY: JL, DB	drawing no. DA – 1301–A	ISSUE A



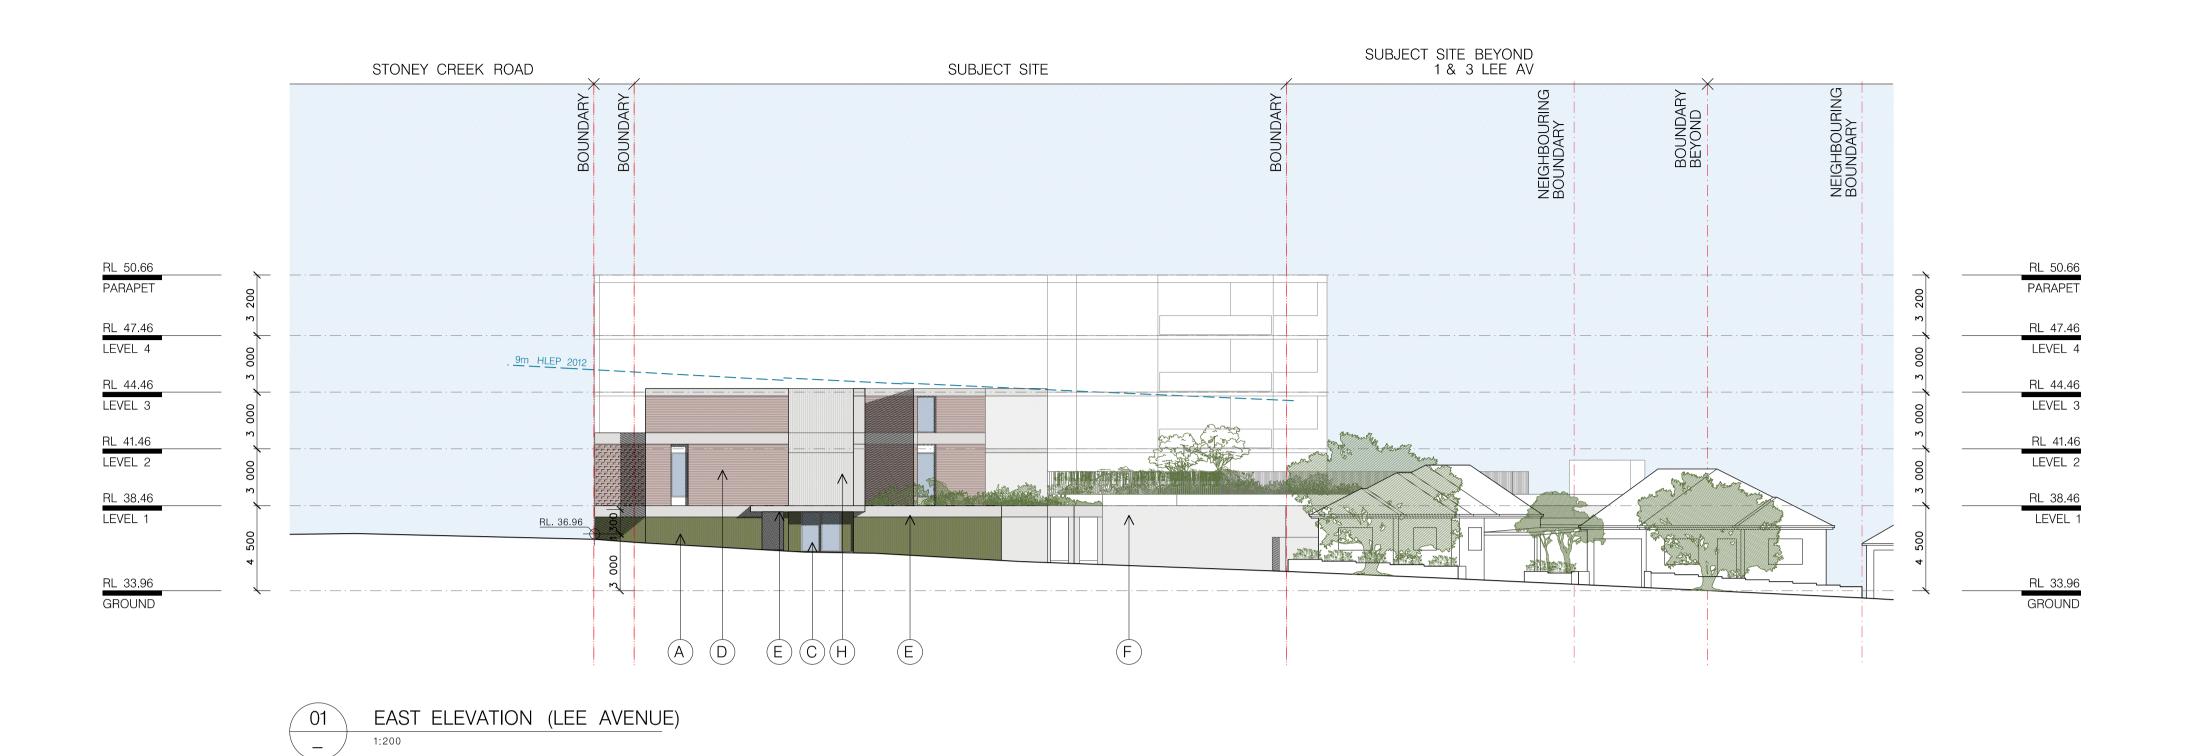

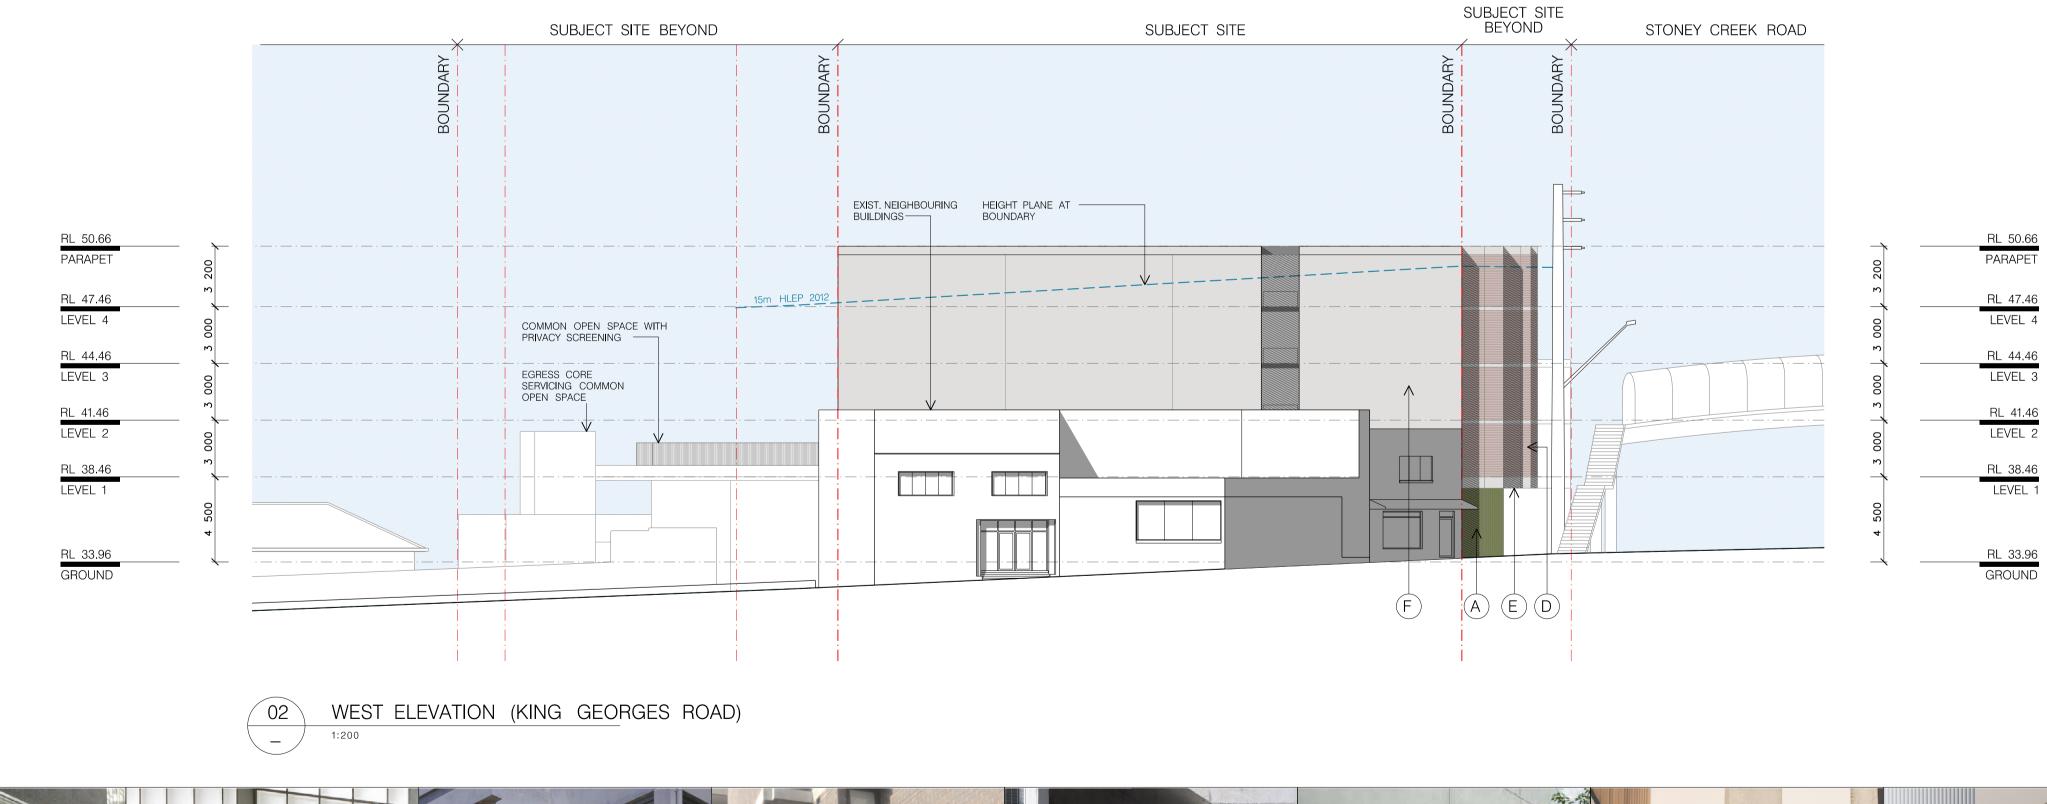


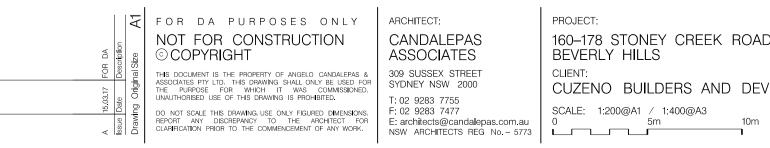

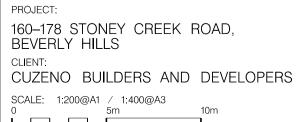


DATE: 15 MAR 2017
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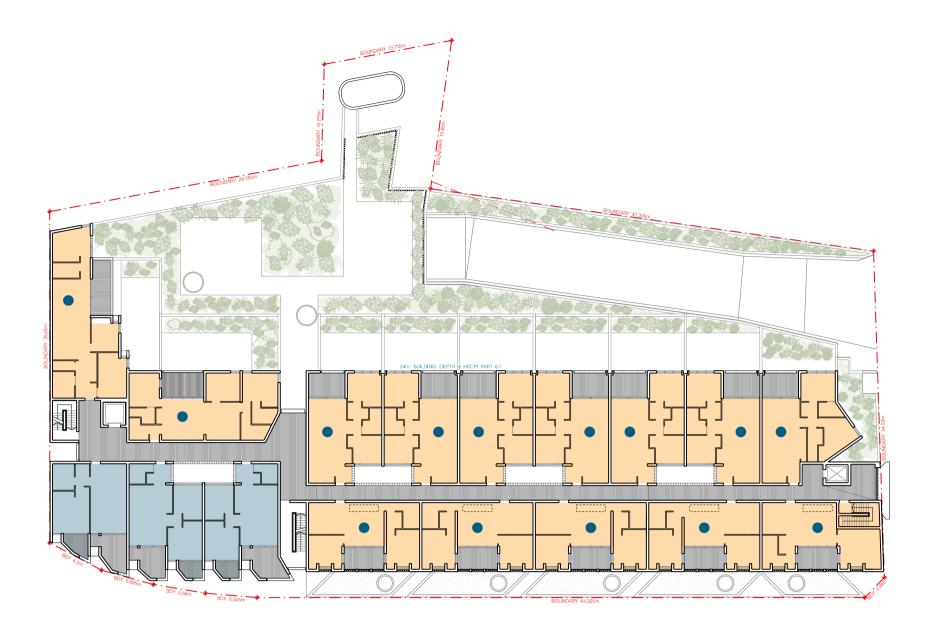


LEVEL 1	
CALCULATIONS FOR JUNE 21, 9AM – 3PM	
MORE THAN 2 HOURS OF DIRECT SOLAR ACCESS 9	JNITS
LESS THAN 2 HOURS OF DIRECT SOLAR ACCESS 8	JNITS
NATURAL CROSS VENTILATION 8	JNITS
TOTAL NUMBER OF UNITS 17	JNITS

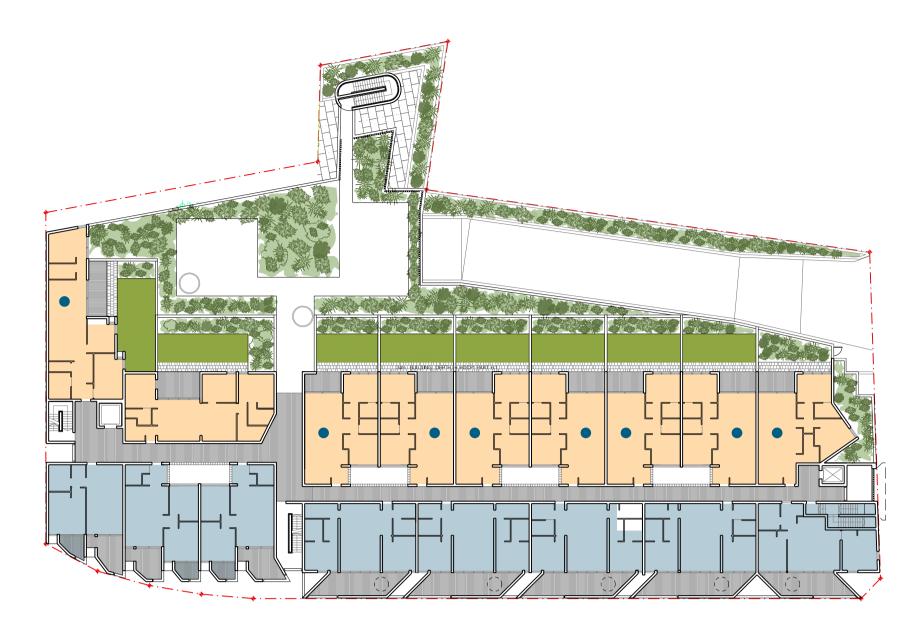


LEVEL 3

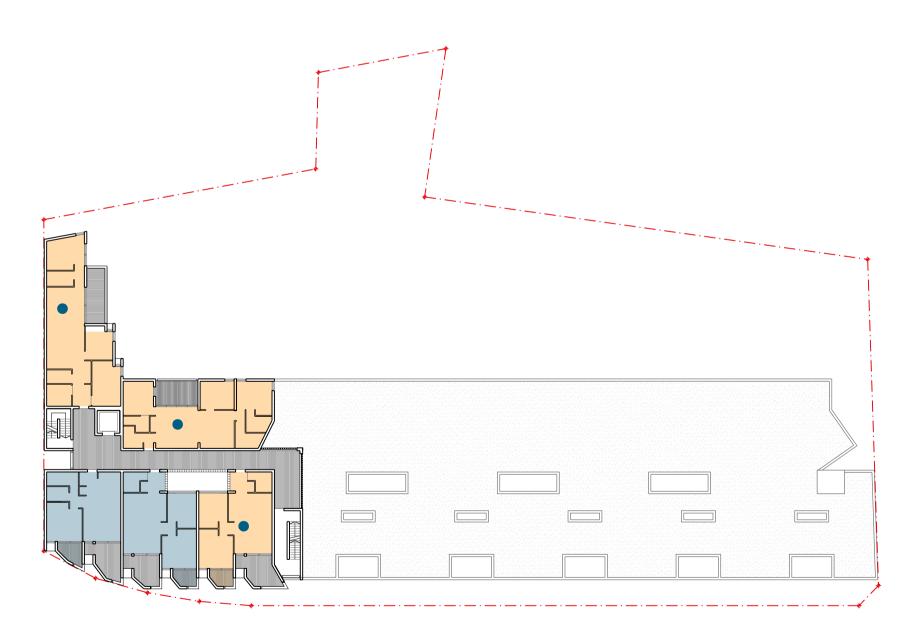CALCULATIONS FOR JUNE 21, 9AM - 3PM	
MORE THAN 2 HOURS OF DIRECT SOLAR ACCESS	3 UNITS
LESS THAN 2 HOURS OF DIRECT SOLAR ACCESS	2 UNITS
NATURAL CROSS VENTILATION	3 UNITS
TOTAL NUMBER OF UNITS	5 UNITS



LEV	EL 2	
CALCU	JLATIONS FOR JUNE 21, 9AM – 3PM	
	MORE THAN 2 HOURS OF DIRECT SOLAR ACCESS	14 UNITS
	LESS THAN 2 HOURS OF DIRECT SOLAR ACCESS	3 UNITS
	NATURAL CROSS VENTILATION	14 UNITS
	TOTAL NUMBER OF UNITS	17 UNITS

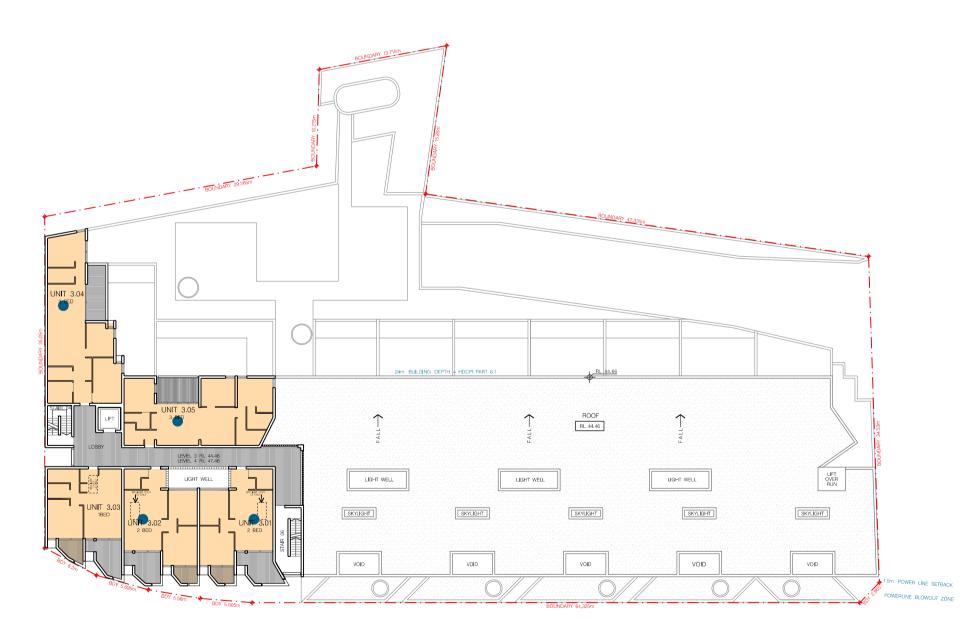

LEVEL 4

MORE THAN 2 HOURS OF DIRECT SOLAR ACCESS	5 UNITS
LESS THAN 2 HOURS OF DIRECT SOLAR ACCESS	0 UNITS
NATURAL CROSS VENTILATION	4 UNIT
TOTAL NUMBER OF UNITS	5 UNITS

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 CLIENT: CUZENO BUILDE

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 CLIENT:

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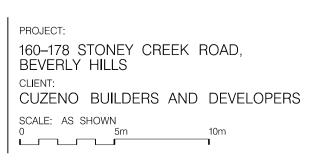
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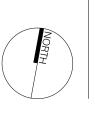
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NATURAL CROSS VENTILATION SUMMARY BY LEVEL	CROSS VENTILATION	NO CROSS VENTILATION
LEVEL 1	8	9
LEVEL 2	14	3
LEVEL 3	2	3
LEVEL 4	4	1
TOTAL	28	16
PERCENTAGE (44 UNITS TOTAL)	64%	18%

SOLAR ACCESS SUMMARY BY LEVEL	MORE THAN 2 HOURS OF DIRECT SOLAR ACCESS	LESS THAN 2 HOURS OF DIRECT SOLAR ACCESS
LEVEL 1	9	8
LEVEL 2	14	3
LEVEL 3	3	2
LEVEL 4	5	0
TOTAL	31	13
PERCENTAGE (44 UNITS TOTAL)	70%	30%






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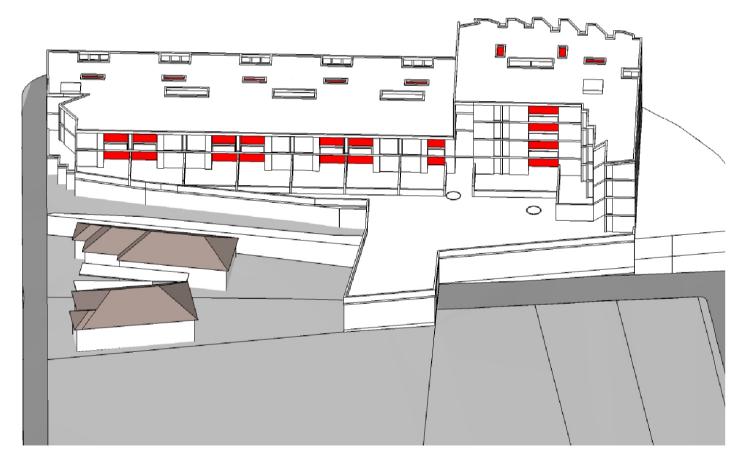
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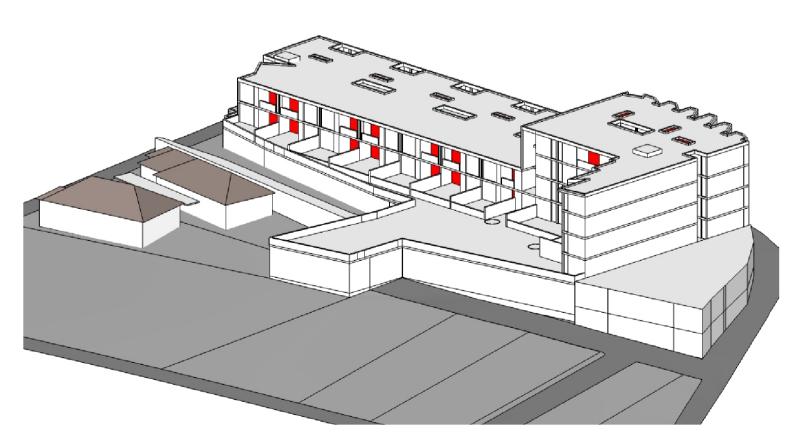





VIEW FROM THE SUN – 9AM 9 AM – JUNE 21

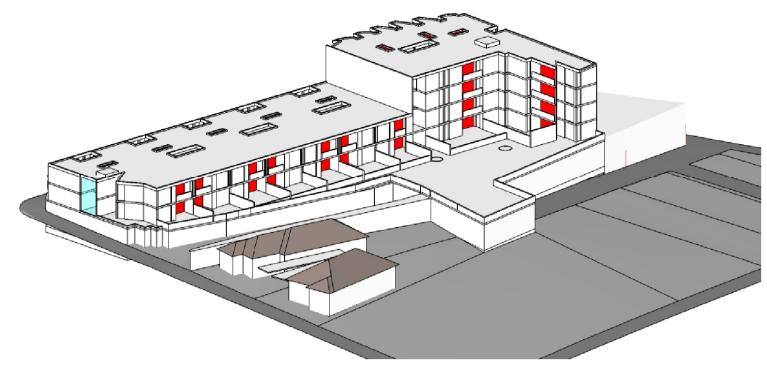


VIEW FROM THE SUN – 12PM 9 AM – JUNE 21




VIEW FROM THE SUN – 3PM 9 AM – JUNE 21

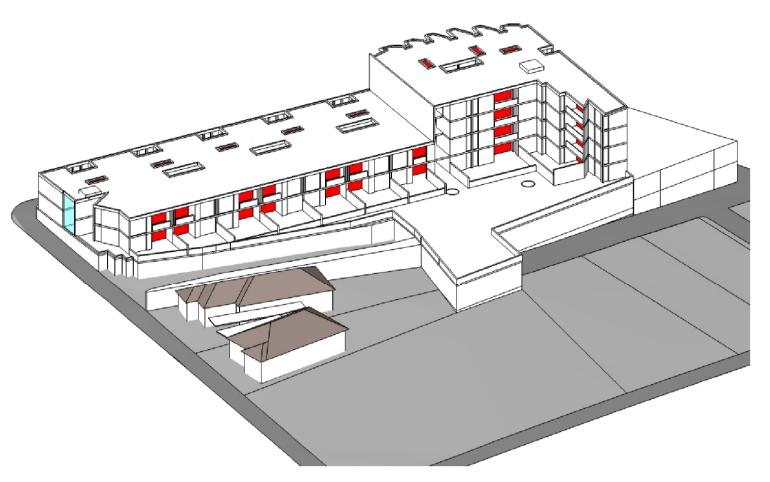


VIEW FROM THE SUN – 10AM 9 AM – JUNE 21

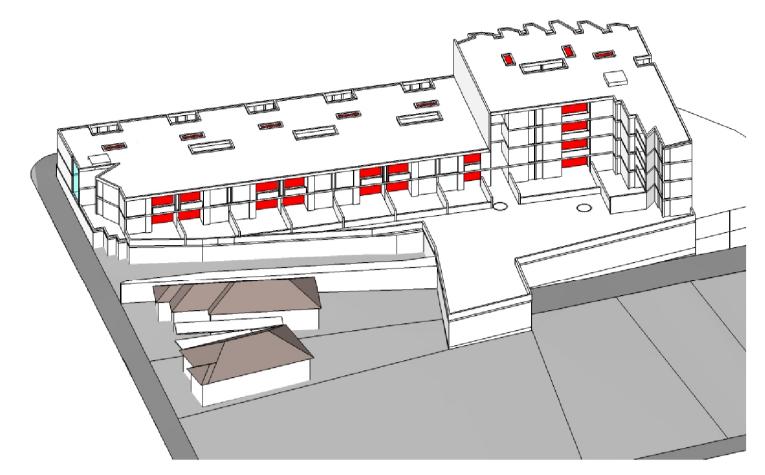

VIEW FROM THE SUN – 11AM 9 Am – JUNE 21

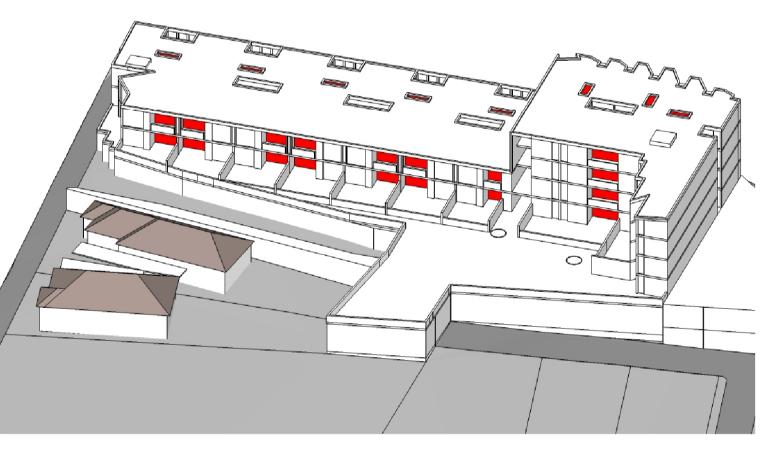

VIEW FROM THE SUN – 1PM 9 Am – JUNE 21

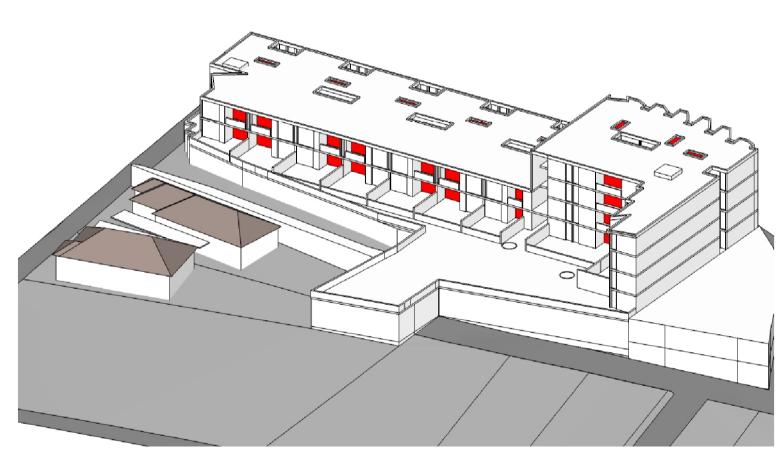

VIEW FROM THE SUN – 2PM 9 AM – JUNE 21


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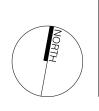
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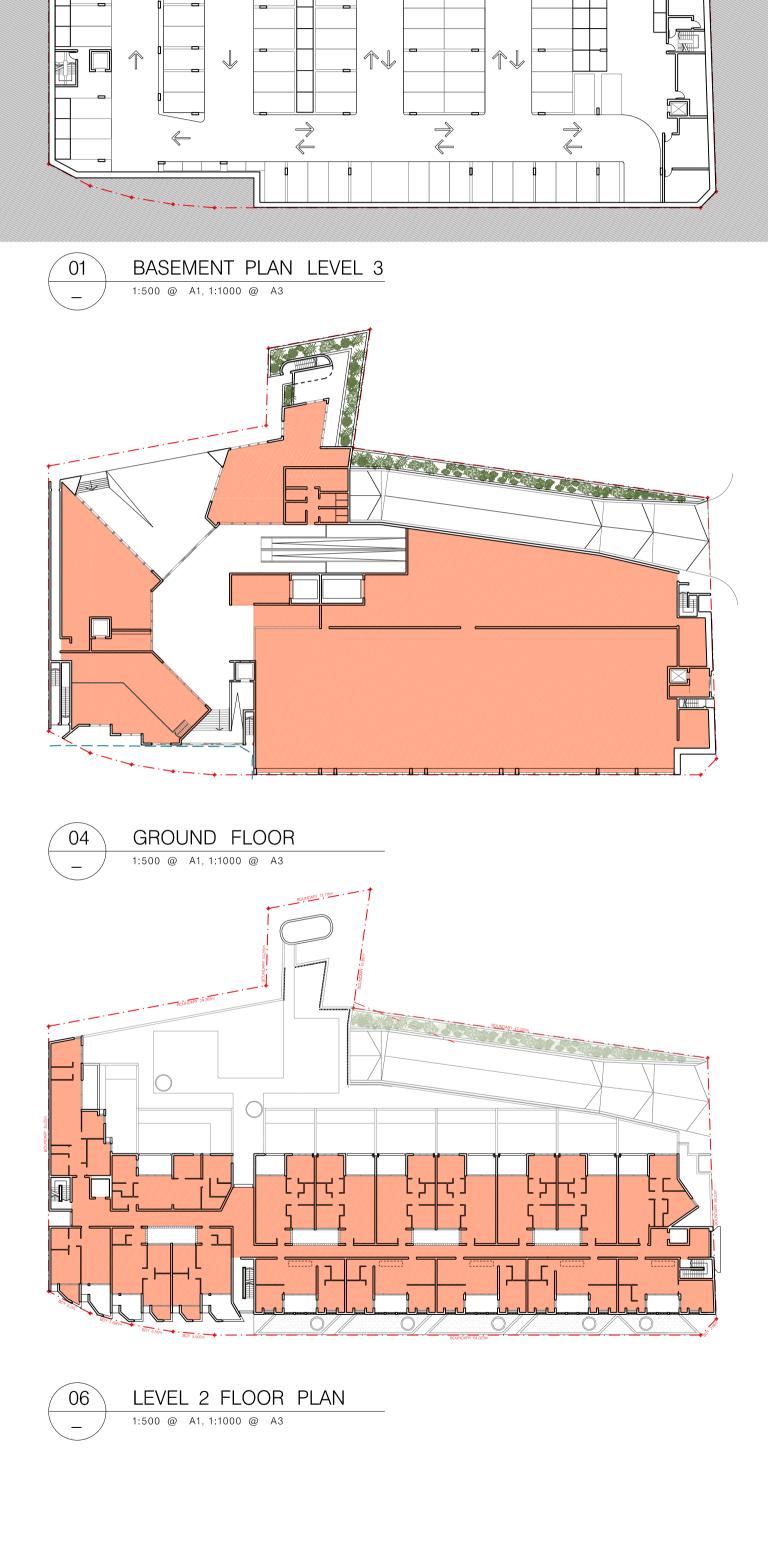



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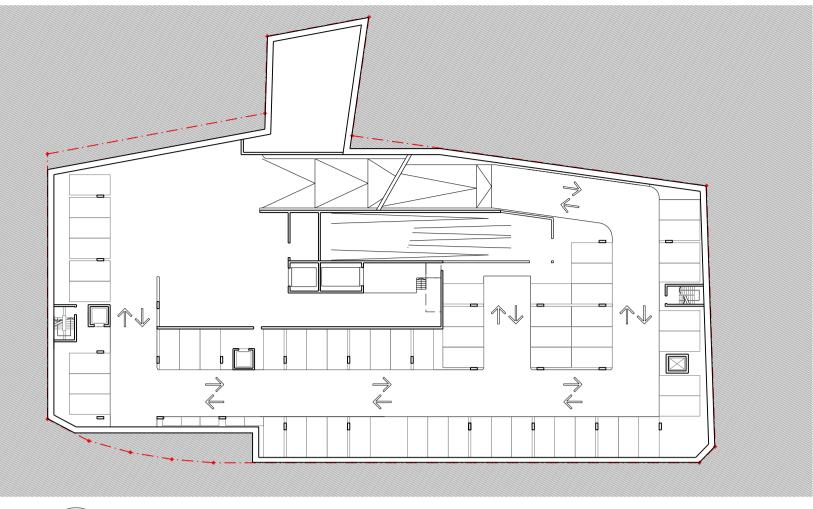
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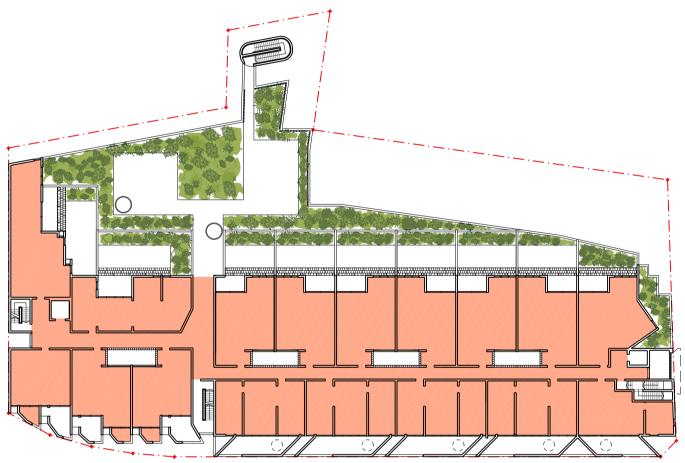









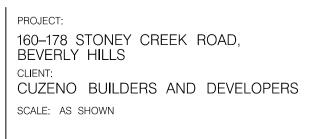

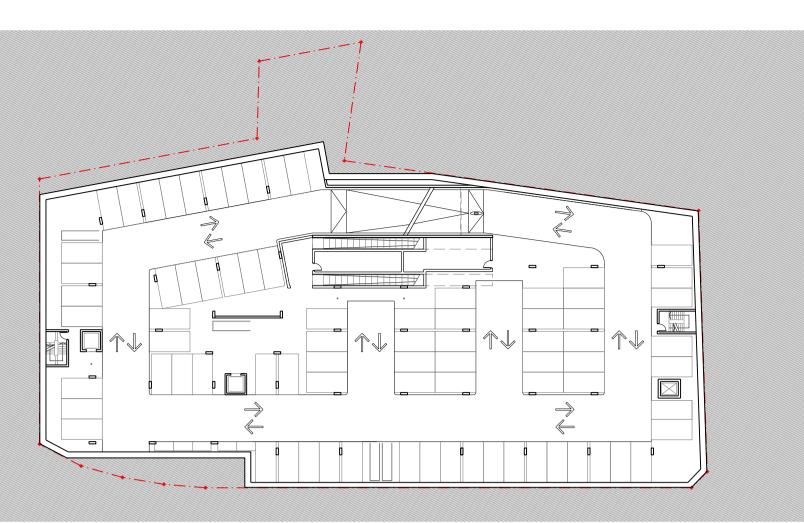

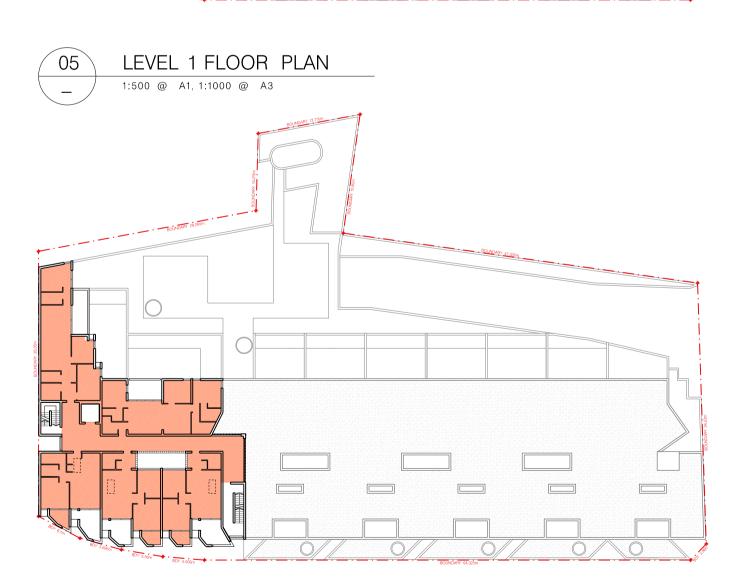

LEVEL 3 AND 4 FLOOR PLAN 07 1:500 @ A1, 1:1000 @ A3 _



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DEVELOPMENT ANALYSIS

EAST SITE WEST SITE TOTAL SITE AREA	2 602 SQM (69 % OF TOTAL SITE) 1 178 SQM (31 % OF TOTAL SITE) 3 780 SQM	
PERMISSIBLE	FSR – EAST SITE FSR – WEST SITE GFA – EAST SITE GFA – WEST SITE GFA – MAX FSR – TOTAL	1.5 : 1 2.0 : 1 3 866 2 424 6 290 1.66 : 1

GFA CALCULATIONS (m*)

	EAST	WEST	TOTAL
BASEMENT LEVEL 3	_	_	-
BASEMENT LEVEL 2	-	-	-
BASEMENT LEVEL 1	_	_	-
GROUND (RETAIL)	1 741	456	2 197
LEVEL 1 (RESIDENTIAL)	1 070	525	1 595
LEVEL 2 (RESIDENTIAL)	1 004	509	1 513
LEVEL 3 (RESIDENTIAL)	-	490	490
LEVEL 3 (RESIDENTIAL)	-	490	490
TOTAL GFA	3 815	2 470	6 285

FSR CALCULATIONS – COMBINED SITE

SITE AREA		3 780 m ²
	AREA	FSR
RETAIL /COMMERCIAL FACILITIES PROPOSED GFA	2 197	0.58 :1
RESIDENTIAL COMPONENT PROPOSED GFA	4 088	1.08 :1
TOTAL PROPOSED GFA	6 262	1.66 :1

FSR CALCULATIONS – BY EAST AND WEST SITE AREA

EAST SITE WEST SITE		2 602 m ² 1 178 m ²
	AREA	FSR
PROPOSED GFA EAST	3 815	1.47 :1
PROPOSED GFA WEST	2 470	2.10 : 1

PROPOSED DEVELOPMENT MIX

	1 BED	2 BED	3 BED	UNIT/LEVEL
LEVEL 1	1	14	2	17
LEVEL 2	2	13	2	17
LEVEL 3	1	2	2	5
LEVEL 4	1	2	2	5
TOTAL	5 (11%)	31 (71%)	8 (18	8%) 44
			5 /	ADAPTABLE*

*HDCP REQUIRES 1 ADAPTABLE UNIT PER 10 DWELLINGS OR PART THEREOF





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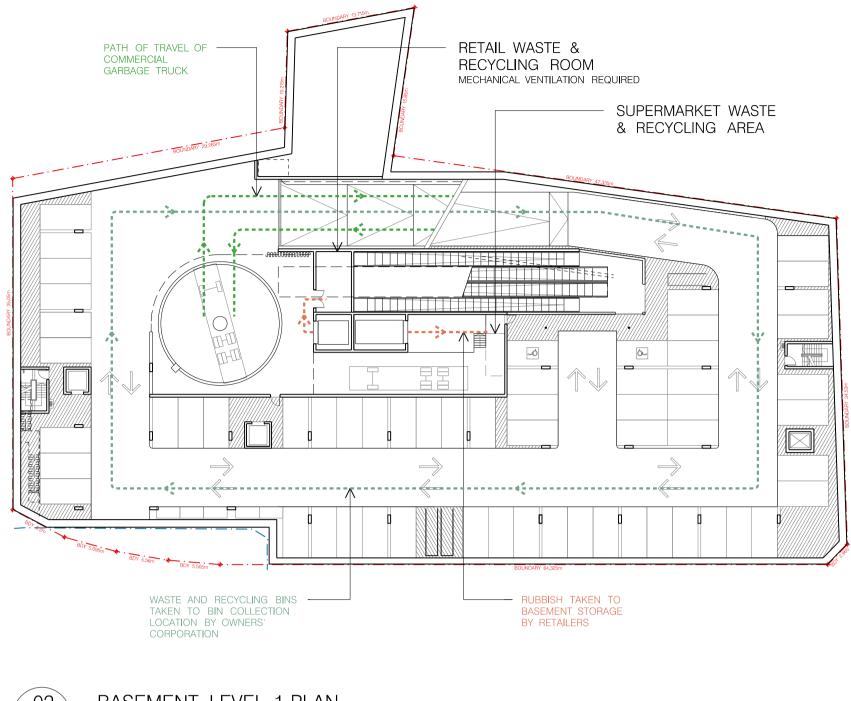
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DRAWING: 8 MAY 2017 CHECKED 1: CALCULATIONS







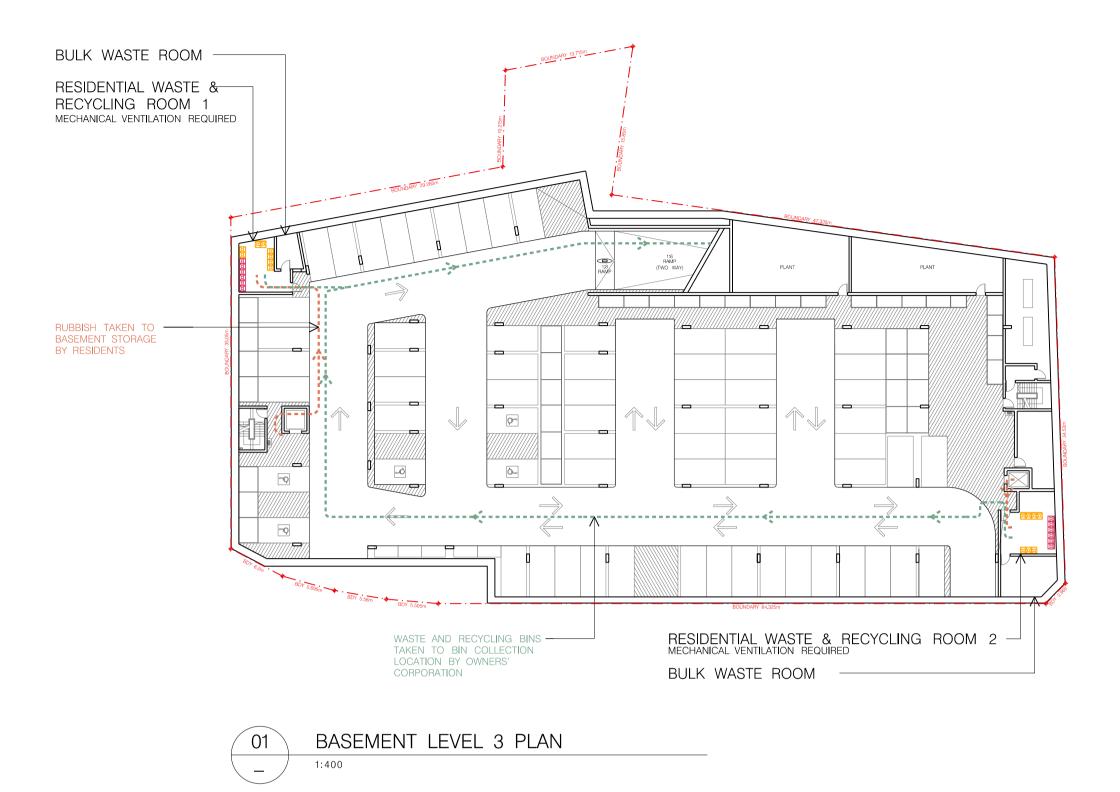

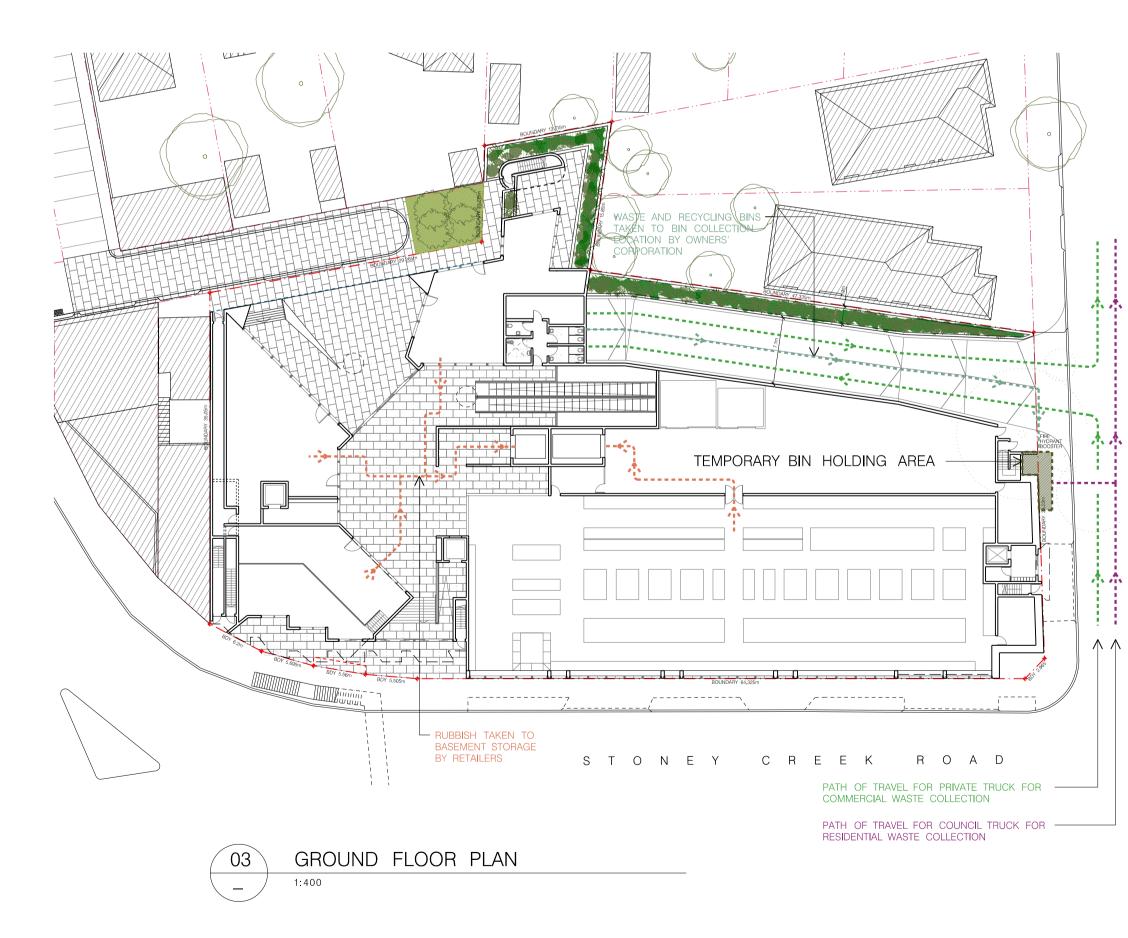

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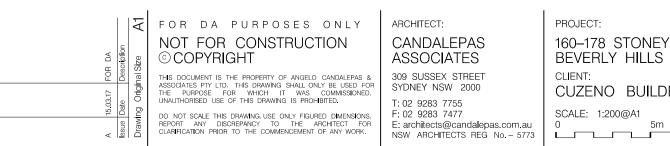
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BASEMENT LEVEL 1 PLAN 1:400



LEVEL ONE PLAN (INDICATIVE OF RESIDENTIAL LEVELS)



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ONGOING WASTE GENERATION CALCULATIONS - RESIDENTIAL WASTE

TOTAL NUMBER OF UNITS:	44 UNITS
NOTE: WASTE GENERATION RATES DERIVED FROM (AMENDMENT NO. 5) – APPENDIX 1 – 'WASTE MANAGE	
GARBAGE WASTE	
WEEKLY GARBAGE GENERATION RATE PER UNIT: WEEKLY GARBAGE GENERATION RATE ALL UNITS:	120L 120L X 44 = 5280L
GARBAGE BIN ALLOCATION:	
1 x 240L GARBAGE BIN PER 4 UNITS COLLECTED TWICE WEEKLY	44 UNITS /4 = 11 GARBAGE BINS
RECYCLING WASTE	
WEEKLY RECYCLING GENERATION RATE PER UNIT: WEEKLY RECYCLING GENERATION RATE ALL UNITS:	80L 80L X 44 = 3520L
RECYCLING BIN ALLOCATION:	
1 x 240L RECYCLING BIN PER 3 UNITS COLLECTED WEEKLY	44 UNITS /3 = 15 RECYCLING BINS
TOTAL BINS PROVIDED	26 x 240L BINS
BIN STORES	
RESIDENTIAL WASTE ROOM 1 6 X 240L GARBAGE BINS + 8 X 240L RECYCLING	BINS
RESIDENTIAL WASTE ROOM 2	

5 X 240L GARBAGE BINS + 7 X 240L RECYCLING BINS

ONGOING WASTE GENERATION CALCULATIONS - COMMERCIAL WASTE

TOTAL GENERAL RETAIL SPACE: 602m2 NOTE: WASTE GENERATION RATES DERIVED FROM HURSTVILLE DCP NO. 1 (AMENDMENT NO. 5) – APPENDIX 1 – 'WASTE MANAGEMENT PLAN'

GARBAGE GENERATION RATE:	
GENERAL RETAIL	50L /100m2 /DAY
FOOD PREMISES	80L /100m2 /DAY
CAFE /RESTAURANT	10L /1.5m2 /DAY
RECYCLING WASTE	
RECYCLING GENERATION RATE:	
GENERAL RETAIL	50L /100m2 /DAY
FOOD PREMISES	VARIABLE
CAFE /RESTAURANT	2L /1.5m2 /DAY

TOTAL SUPERMARKET SPACE:	1529m2
GARBAGE WASTE	
GARBAGE GENERATION RATE:	
SUPERMARKET	240L /100m2 /DAY
TOTAL GARBAGE WASTE	3840L /DAY
RECYCLING WASTE	
RECYCLING GENERATION RATE:	
SUPERMARKET	240L /100m2 /DAY
TOTAL RECYCLING WASTE	3840L /DAY


---- PATH OF TRAVEL – TO ON STREET WASTE PICK-UP


- ----- RESIDENTS /OWNERS CORPORATION /RETAIL PATH OF TRAVEL TO WASTE STORAGE ROOM
- ----- GARBAGE TRUCK PATH OF TRAVEL PRIVATE CONTRACTOR FOR COMMERCIAL WASTE COLLECTION
- ----- GARBAGE TRUCK PATH OF TRAVEL COUNCIL TRUCK FOR RESIDENTIAL WASTE COLLECTION
- WASTE BIN (240L)

LEGEND

- RECYCLE BIN (240L)
- GREEN WASTE BIN (240L)

- WASTE PICKUP LOCATION

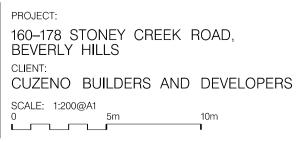

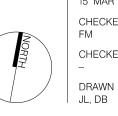

DATE: 15 MAR 2017 CHECKED 1: FM CHECKED 2 DRAWN BY:

DRAWING: WASTE MANAGEMENT PLAN


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DRAWING No. DA – 1851

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NOMINATED LOCATION OF REUSABLE AND RECYCLABLE MATERIALS STORAGE DURING DEMOLITION NOMINATED LOCATION OF WASTE STORAGE DURING DEMOLITION LOCATION FOR STOCKPILING OF EXCAVATED	
MATERIALS	
AREA OF EXCAVATION	



FOR DA	Description	Original Size A1	FOR DA NOT FO © COPYI
15.03.17	Date		ASSOCIATES PTY THE PURPOSE UNAUTHORISED L DO NOT SCALE 1
A	ssue	Drawing	REPORT ANY CLARIFICATION PF

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CANDALEPAS ASSOCIATES

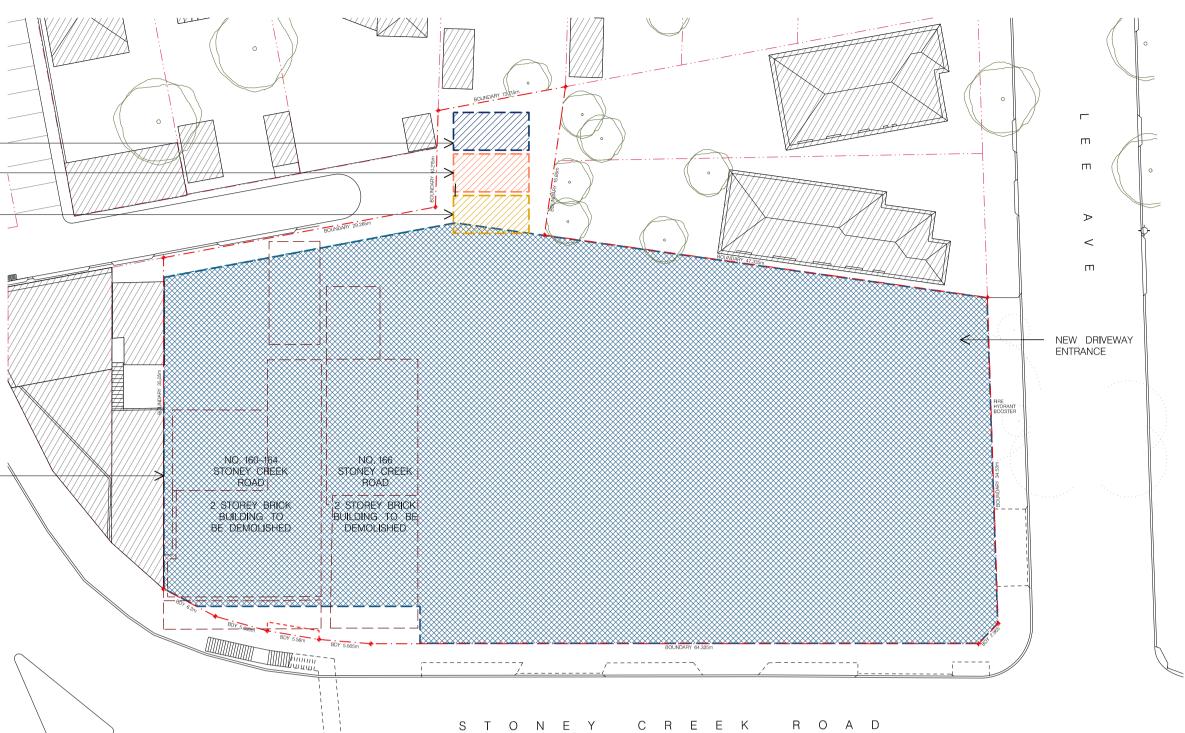CONSTRUCTION WASTE MANAGEMENT WASTE & MATERIALS HANDLING

ALL CONSTRUCTION AND WASTE MATERIALS TO BE STORED IN BASEMENT CARPARK DURING CONSTRUCTION STAGE.SITE SHED AND AMENITIES LOCATED IN BASEMENT CARPARK FOR THE DURATION OF THE CONSTRUCTION PERIOD.

ALL DEMOLITION AND EXCAVATION MATERIALS TO BE COLLECTED DAILY FROM SITE DURING DEMOLITION /EXCAVATION STAGE. WATER & SEDIMENT CONTROL MEASURES

1. PRE-EXISTING SITE ACCESS POINTS ARE RETAINED DURING CONSTRUCTION, SITE ACCESS POINTS ARE STABILISED WITH GEO-TEXTILE FABRIC AND BLUE METAL A VEHICLE GRID ENSURES MINIMAL SOIL PARTICLES ARE REMOVED FROM THE SITE.

2. GEO-TEXTILE SEDIMENT FENCES ARE LOCATED ALONG THE LOWER SITE BOUNDARIES TO PREVENT RUNOFF.

3. KERBSIDE DRAINS ARE PROTECTED WITH GRAVEL SAUSAGES. 4. MATERIAL STOCKPILES ARE COVERED AND LOCATED WITHIN SEDIMENT

FENCES.

5. EXCAVATED MATERIAL IS PLACED UPSLOPE OF SERVICE TRENCHES. TRENCHES ARE FILLED AND COMPACTED IMMEDIATELY AFTER INSTALLATION OF SERVICES.

6. PAVED AREAS AND FOOTPATHS ARE SWEPT DAILY AND SEDIMENT IS COLLECTED. 7. EROSION AND SEDIMENT CONTROLS ARE TO BE CHECKED DAILY AND REPAIRED WHEN NECESSARY.

LEGEND

AREA TO BE EXCAVATED

////// - MATERIALS FOR REUSE /RECYCLING

ZZZ – WASTE MATERIALS


ZZZ - EXCAVATION MATERIALS





DATE: 15 MAR 2017 CHECKED 2: -DRAWN BY: JL, DB


DRAWING: WASTE CHECKED 1:MANAGEMENT $\stackrel{\leftarrow}{m}$ $\stackrel{\leftarrow}{m}$ FMPLAN - SHEET 02 $\stackrel{\leftarrow}{g}$ $\stackrel{\leftarrow}{g}$ drawing no. DA – 1852

8 9 ∾ ISSUE A

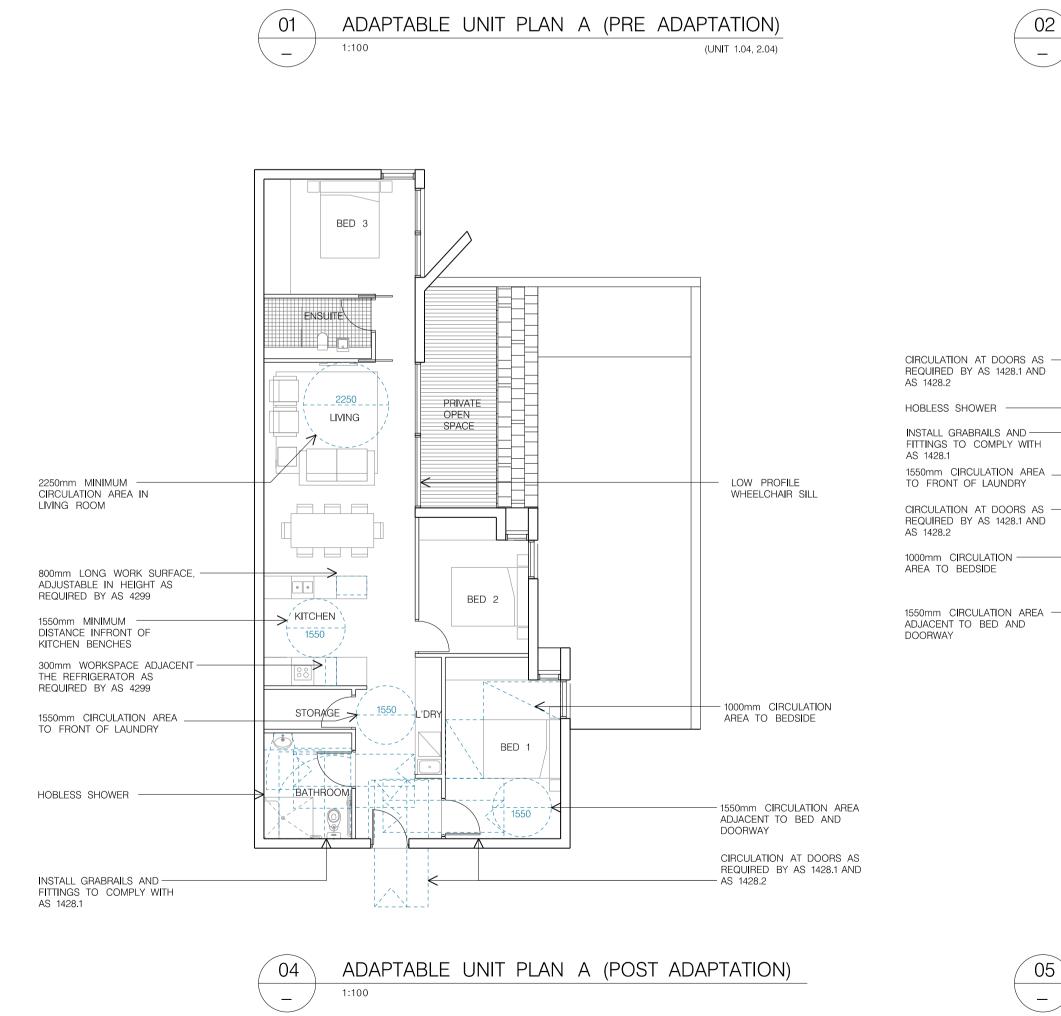

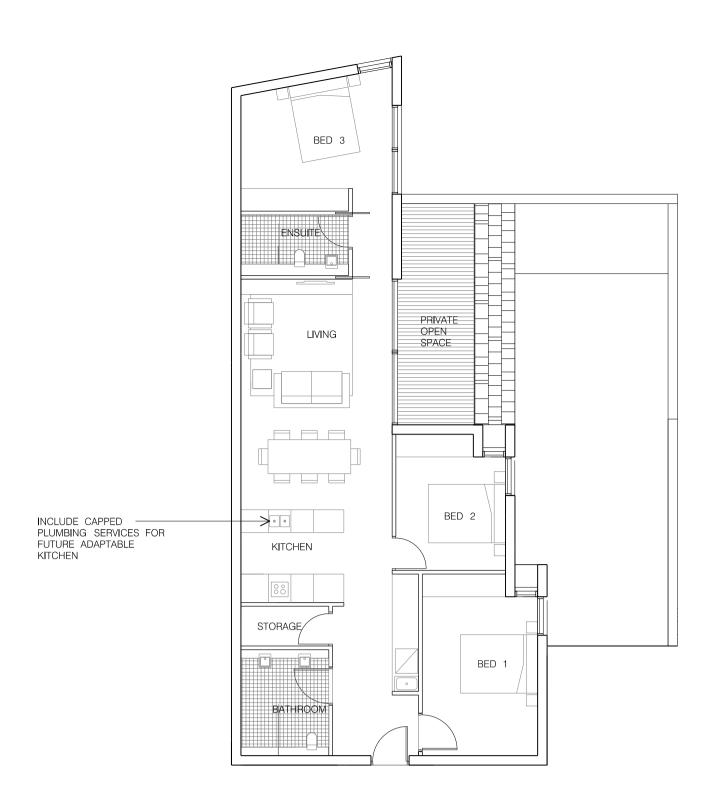

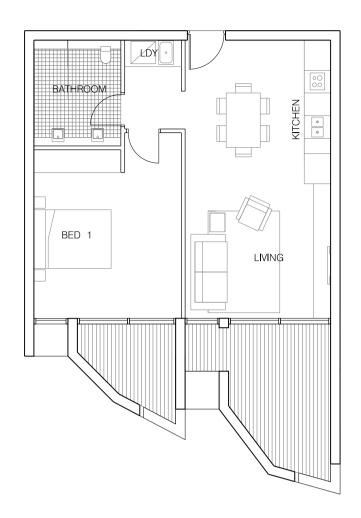


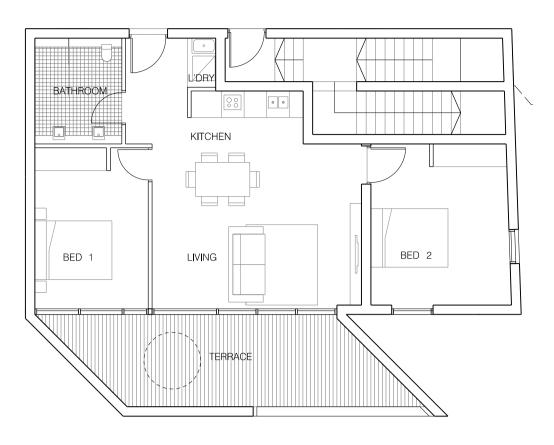







NEEDE

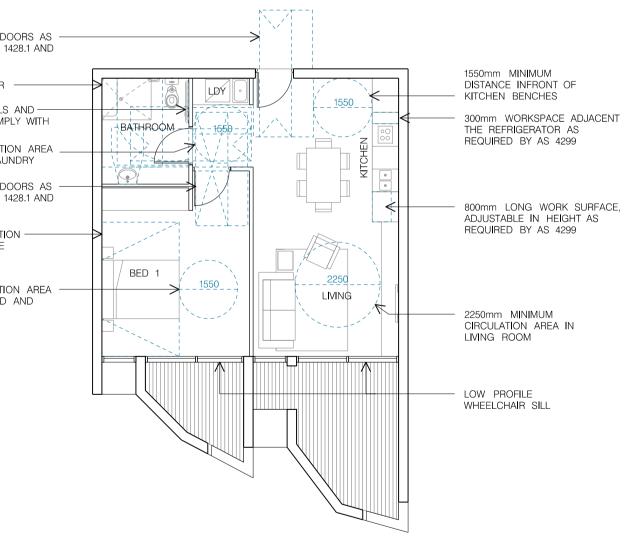

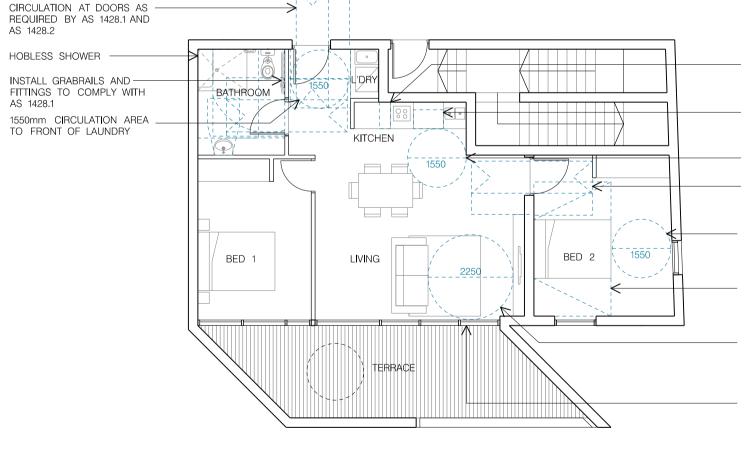



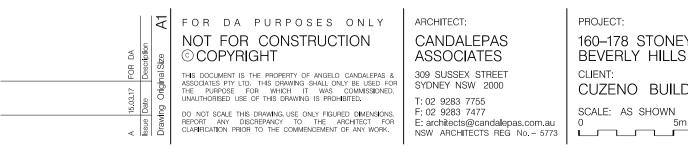



ADAPTABLE UNIT PLAN B (POST ADAPTATION) 1:100

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300mm WORKSPACE ADJACENT THE REFRIGERATOR AS REQUIRED BY AS 4299

800mm LONG WORK SURFACE, ADJUSTABLE IN HEIGHT AS REQUIRED BY AS 4299


- 1550mm CIRCULATION AREA TO FRONT OF LAUNDRY CIRCULATION AT DOORS AS REQUIRED BY AS 1428.1 AND AS 1428.2


1550mm CIRCULATION AREA ADJACENT TO BED AND ROBE

1000mm CIRCULATION AREA TO BEDSIDES

2250mm MINIMUM CIRCULATION AREA IN LIVING ROOM

LOW PROFILE WHEELCHAIR SILL

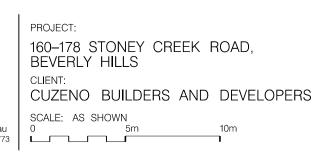

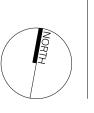


DATE: 15 MAR 2017 CHECKED 1: FM CHECKED 2 DRAWN BY: JL, DB


DRAWING: ADAPTABLE UNIT PLANS


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03 1:200 @ A1 _ _ _

KING

3 GEORGES ROMD

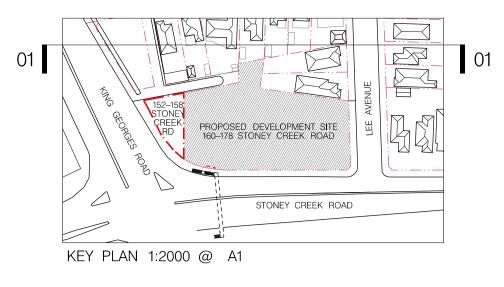PRELIMINARY

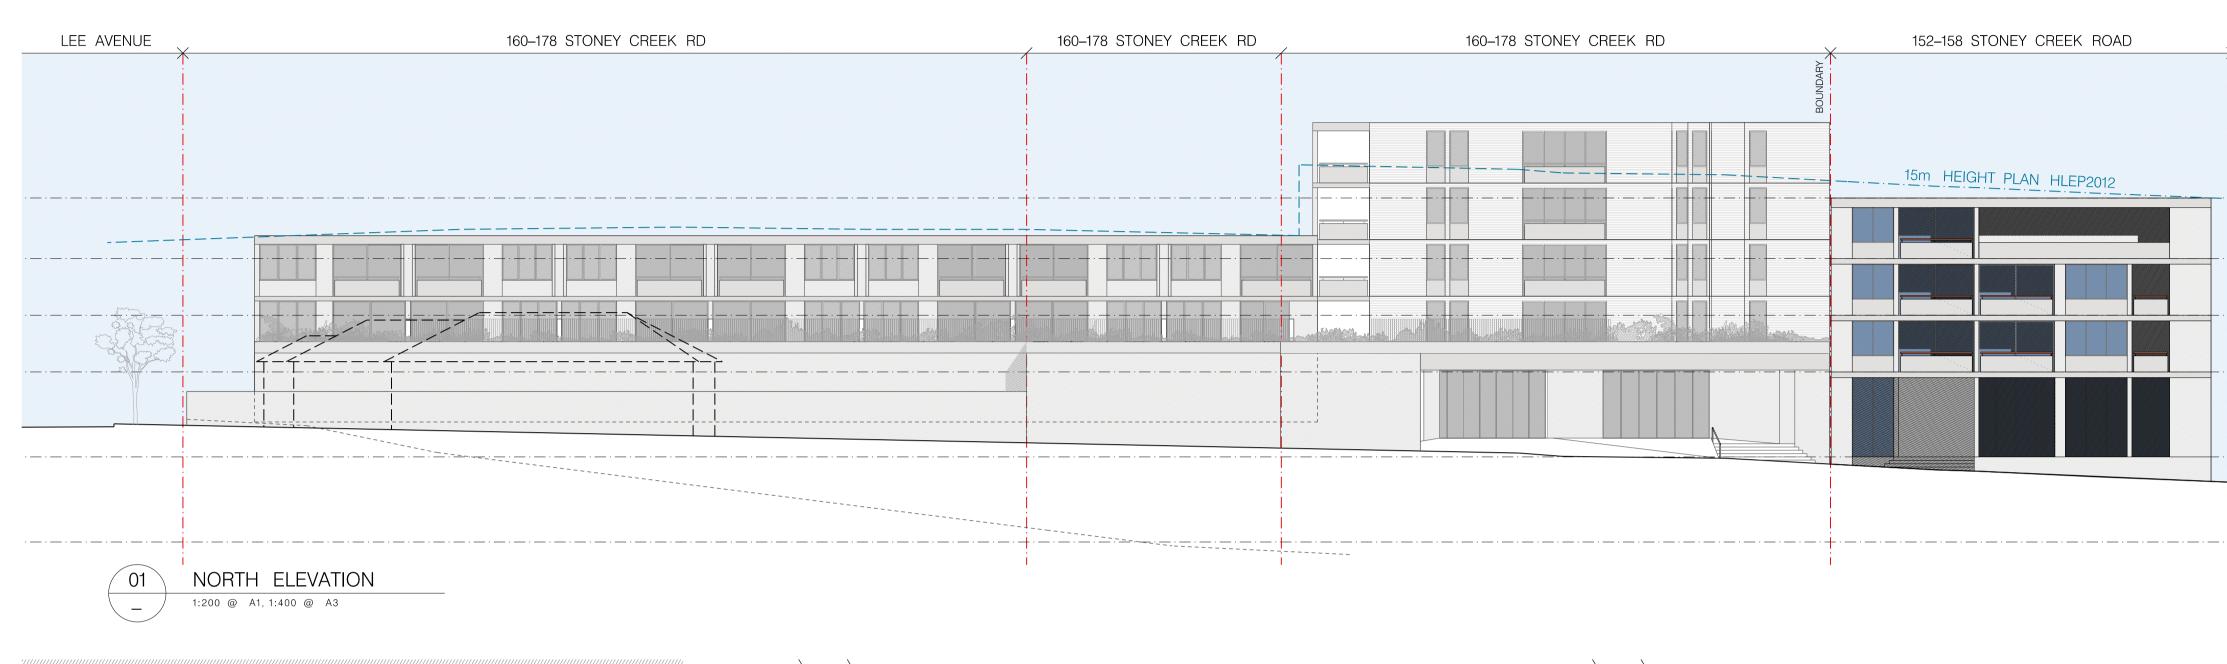

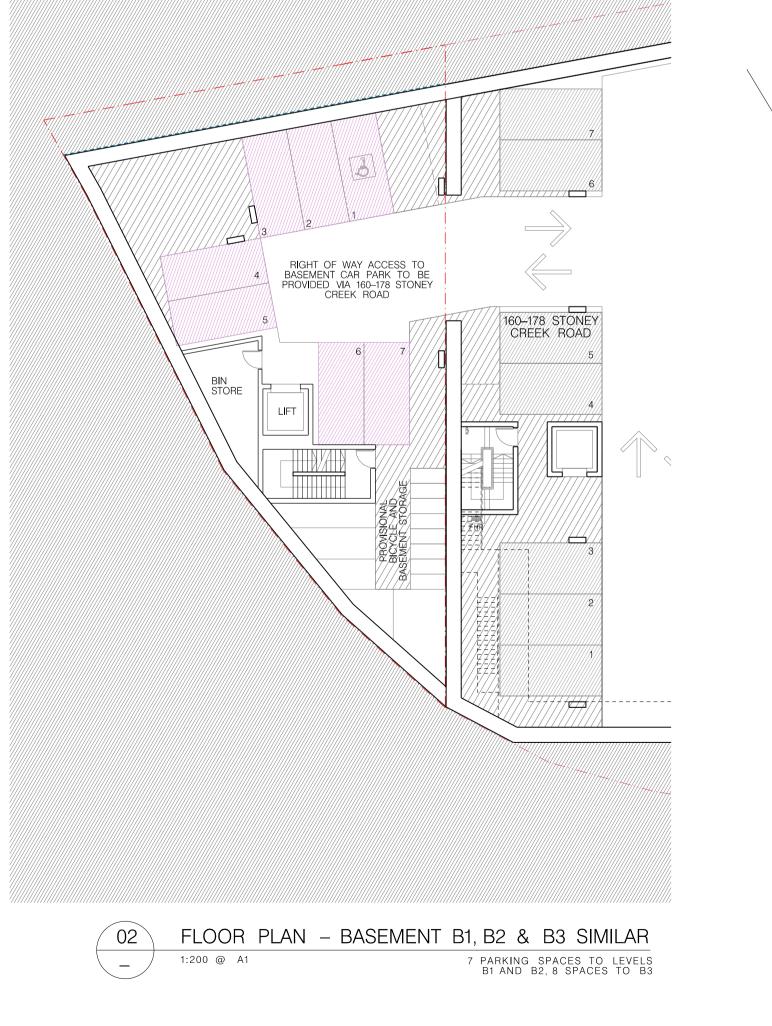			total site	E AREA	425 SQM		
			PERMISSIB	LE	FSR GFA		2 :1 850 SQM
				CALCUL FA m²	ATIONS SITE	FSR	
			G	255			
			L1	224			
			L2	224			
			L3 TOTAL	147 850	425	2:1	
			UNIT N		420	۷.۱	
				1 BED	2	2 BED	3 BED
3			L1	1		2	0
RGES			L2	1		2	0
'D			L3	1		1	0
				3		5	0
			TOTAL	8 (17	ADAPTABLE	Ξ*)	
			*HDCP RE	QUIRES 1 AI S OR PART	DAPTABLE UN THEREOF	NIT PER 10	
			AMENI	TY CALO		NS	
		RL 46.66	LEVEL	SOLAR	ACCESS	CROSS	VENT.
	200	PARAPET	L1 L2		2 2	e e	
	٣ 	RL 43.46	L2 L3		2		
	000	LEVEL 3	TOTAL		6 (75%)	8	3 (100%)
	0	RL 40.46 LEVEL 2	CAR P	ARK SL	JMMARY		
	3 000		RESIDEN	TIAL			8
		RL 37.46 LEVEL 1	x	d space r PARKING ³	,		2
	500		RETAIL F	PARKING** M GLFA)			12
	4	RL 32.96			equired – I	BCA)	
		GROUND	TOTAL				22
	4 500		*RATES AS	PER CLAUS DCP NO.1	SE 4.3.2.6 OF 2012:		APT. – 1 SPACE PER UNIT APT. – 1 SPACE PER UNIT
							APT. – 2 SPACE PER UNI






PHOTOMONTAGE 1 – CORNER OF KING GEORGES ROAD AND STONEY CREEK ROAD



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CANDALEPAS ASSOCIATES 309 SUSSEX STREET SYDNEY NSW 2000



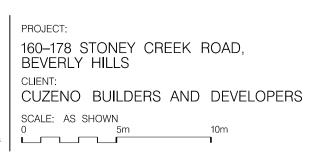

DATE: 15 MAR 2017 CHECKED 1: FM CHECKED 2:

DRAWING: PHOTOMONTAGE

| -| drawing no. | jl, db | DA - 1900





PHOTOMONTAGE 2 - CORNER OF STONEY CREEK ROAD AND LEE AVENUE






DATE: 15 MAR 2017 CHECKED 1: FM CHECKED 2: DRAWN BY: DRAWING No. JL, DB DA - 1901

PHOTOMONTAGE 2 DRAWING:

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AMENDMENTS DATE NOTES REV. 24.01.17 Ammendments А

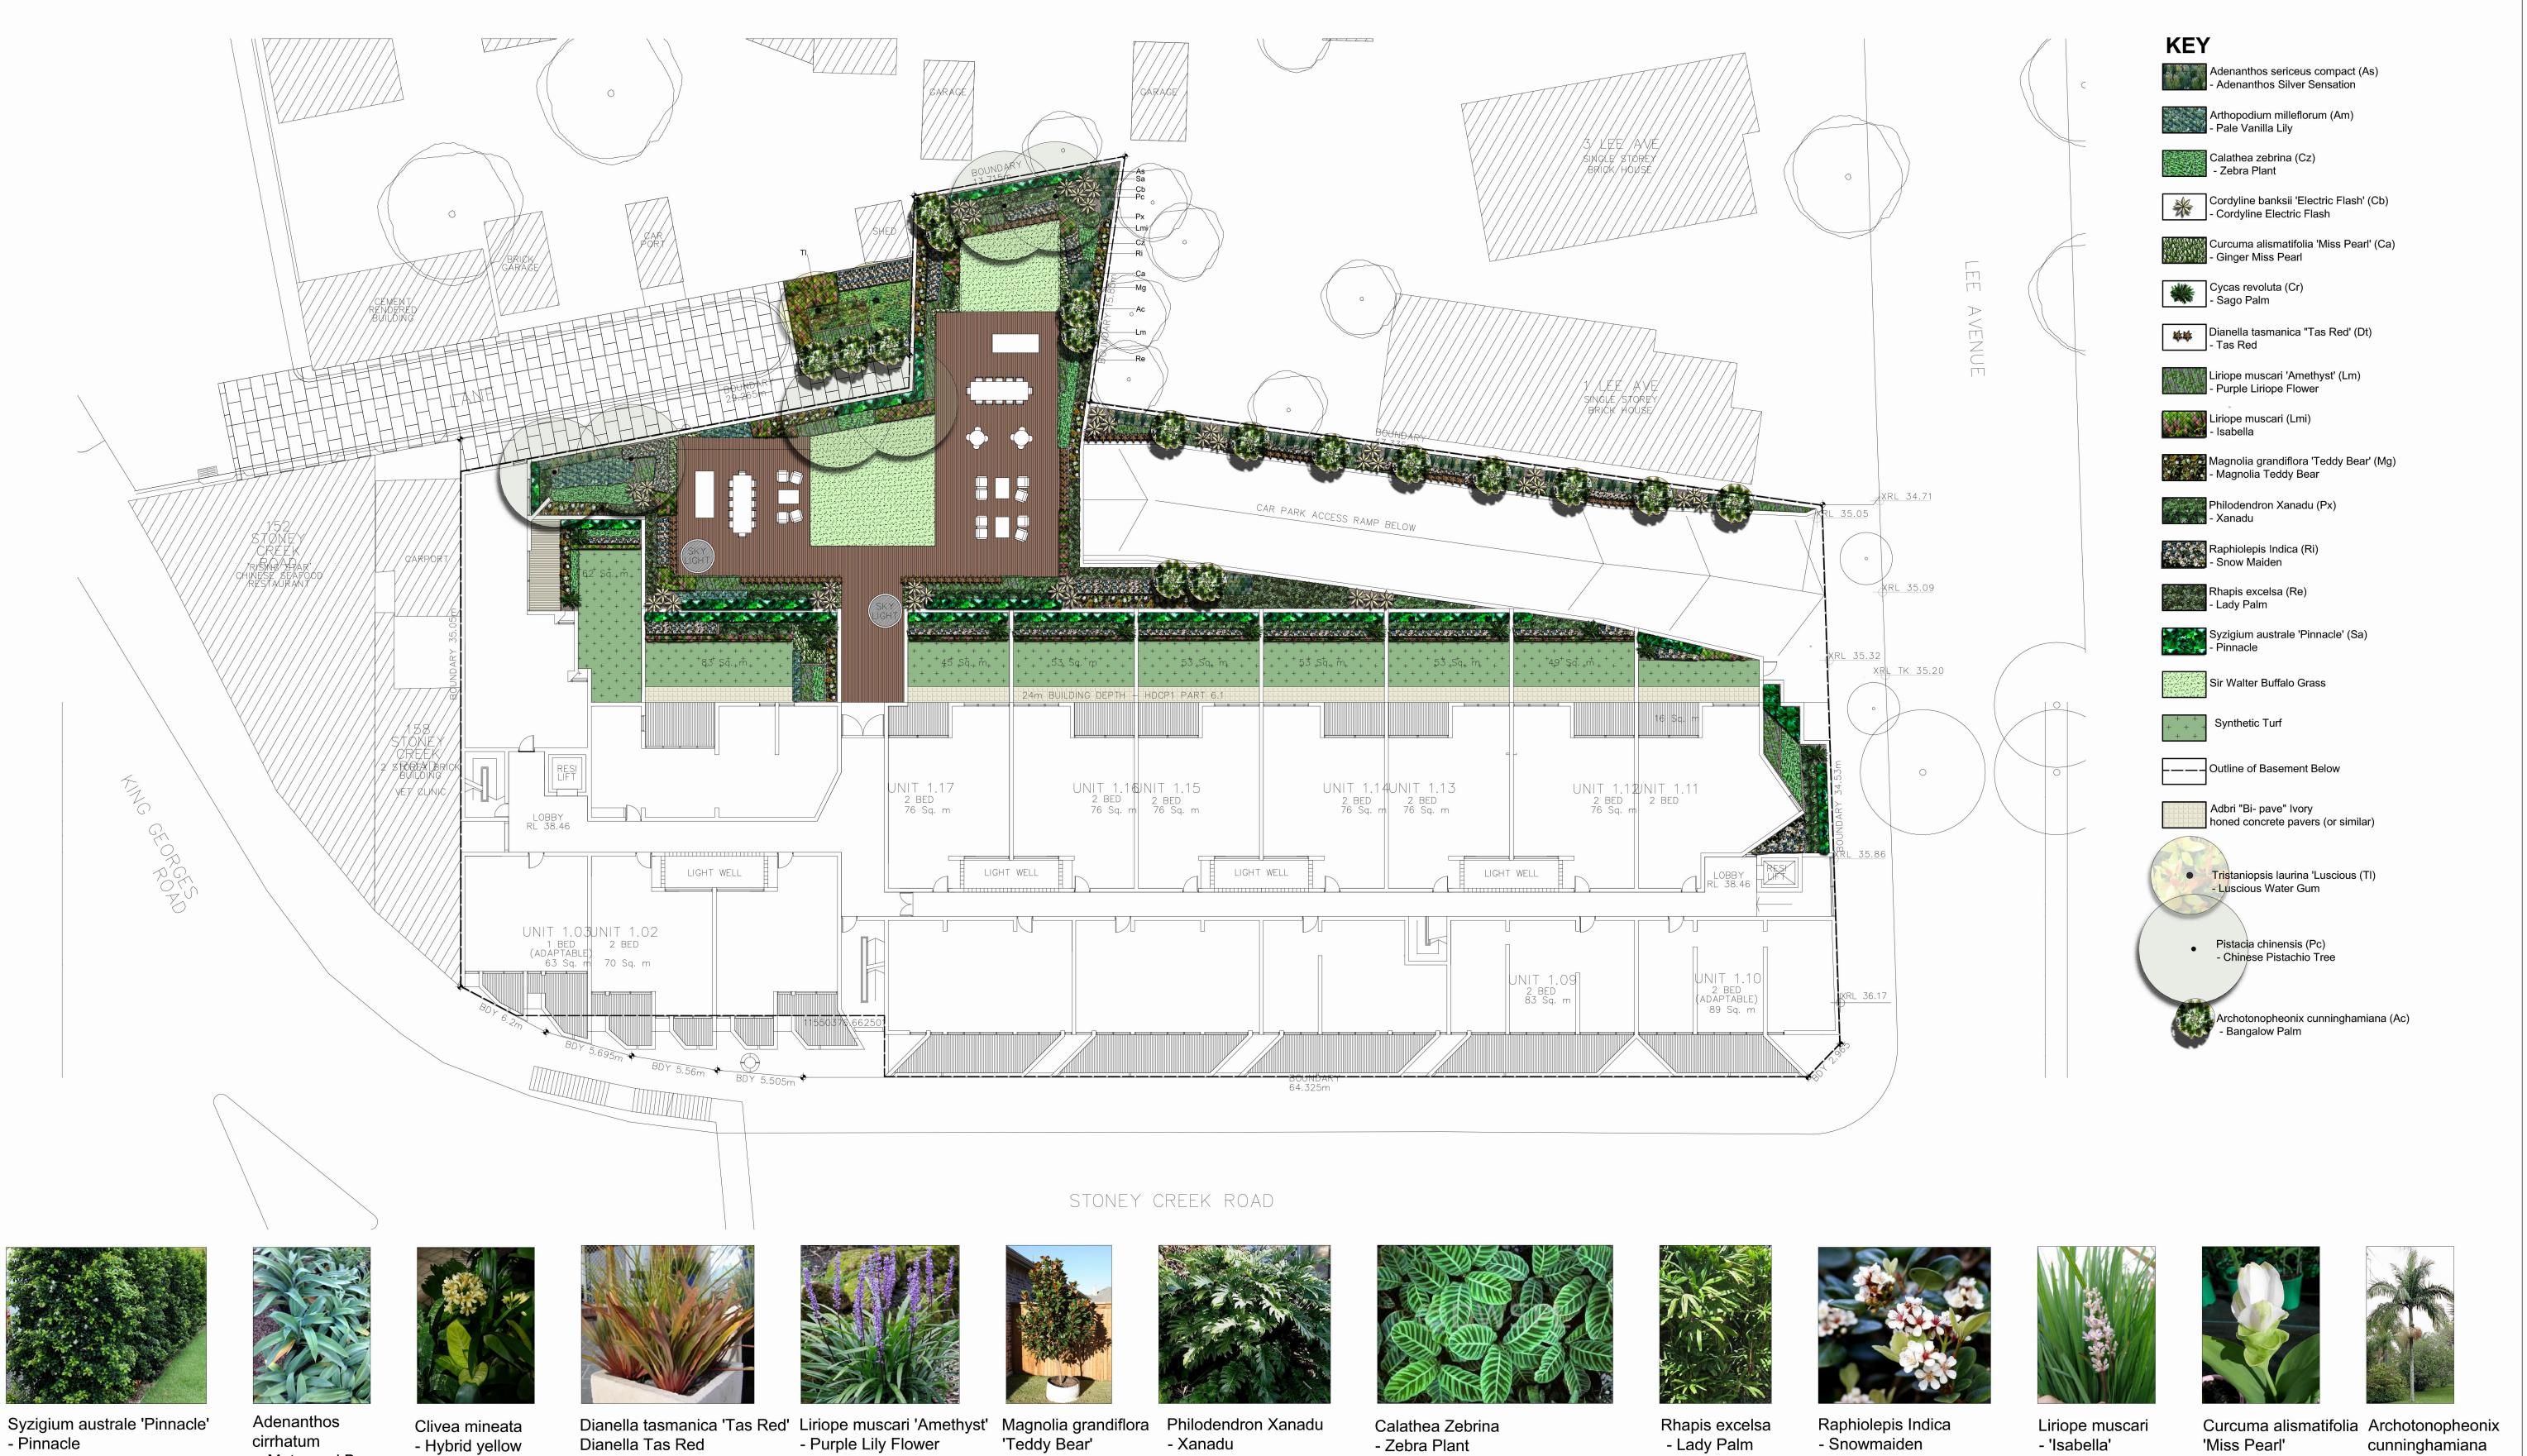NOTES All dimensions to be set out by contractor on site and confirmed by landscape architect prior to construction. Do not scale from drawing. Any discrepancies to be referred to landscape architect.

- Matapouri Bay


Tristaniopsis laurina 'Luscious' - Luscious Water Gum

'Teddy Bear' - Xanadu - Magnolia Teddy Bear

- Zebra Plant

- Lady Palm

- Snowmaiden

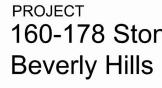





Adenanthos sericeus compact - Adenanthos Silver Sensation



Pistacia chinensis - Chinese Pistacio Tree



- 'Isabella'


'Miss Pearl' - Ginger Miss Pearl - Bangalow Palm

cunninghamiana

PROJECT 160-178 Stoney Creek Rd

Elysium Design Landscape Architecture | Garden Design 33 Bernard Road, Padstow Heights 0410 643 685 cjabbour23@hotmail.com

DRAWING Preliminary Landscape Plan for DA

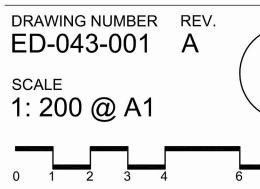



8 metres

Abrev	Botanical Name	Common Name	Spacing (m)/density	Pot Size	Hgt @ Maturity (m)	Notes	Amount
	Trees						To be calculated at
Ac	Archotonopheonix cunninghamiana	Bangalow Palm			8-15m		later stage in design
Mg	Magnolia grandiflora 'TeddyBear'	Magnolia Teddy Bear	0.8	45 Lt	3	Prune to 1.8m hedge	
Pc	Pistacia chinensis	Chinese Pistachio Tree	As Shown	75 Lt	6-10m	Deciduous Tree	
Sa	Syzigium australe 'Pinnacle'	Pinnacle	0.6	300mm	6 to 10	Prune to 2m hedge	
TI	Tristaniopsis laurina 'Luscious	Luscious Water Gum	As shown	75 Lt	5 to 8		
	Shrubs						
Aa	Adenanthos sericeus compact	Adenanthos Silver Sensation	0.6	300mm	1.5m		
Am	Arthopodium milleflorum	Pale Vanilla Lily	0.4	150mm	0.45		
Cb	Cordyline banksii 'Electric Flash'	Cordyline Electric Flash	0.8	300mm	1.2		
Cr	Cycas revoluta	Sago Palm	As shown	25 Lt	1-5m		
Cz	Calathea zebrina	Prayer plant	5/sq m	140mm	0.6		
Px	Philodendron Xanadu	Xanadu	3/m2	140mm	0.5		
Ri	Raphiolepis Indica	Lady Palm			0.6		
	Grasses/ Groundcovers						
Са	Curcuma alismatifolia 'Miss Pearl'	Ginger Miss Pearl	0.4	200mm	0.3		
Dt	Dainella Tasmanic 'Tas Red"	Dianella Tas Red	As shown	150mm	0.5		
Lmi	Liriope muscari 'Isabella'	Lilly Turf	0.3m	140mm	0.3		
Lm	Liriope muscari 'Amethyst'	Lily Flower	0.4	140mm	0.5		

NOTES:

All Landscape Notes must be read in conjunction with Engineers and Architects Plans and Specifications.

Soil Types

- The mix to be used in planting areas above basement is called <u>'Planter Box Mix'</u> from ANL Landscapes in Ryde. The soil mix contains a blend of soil, graded ash, coarse sand, Nepean sand, composted sawdust, Botany Humus Mix and Composted Pine Bark

Paving - Ensure all public walkway paving is to Council DCP specification and as per <u>Architects and</u> Engineers details.

-Mulching


All planting areas to be muclhed with a minimum 75mm thick cover leaf litter mulch called 'Forest Fines' from ANL Landscapes.

Edging 125mm high Everedge Classic Flexible Galvanised Steel Edging is to be used. See section 1. Installation is to be conducted as per manufacturers instructions.

Turfing Sir Walter Buffalo Sapphire grass is to be used as it is the most shade tolerant grass recommended by the producer. Grass is to fully irrigated by automated irrigation.

Irrigation

Fully automatic watering system to be selected. In ground drip line to extend to all planting areas.

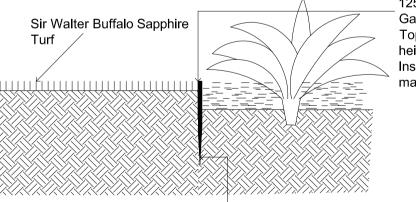

125mm high Everedge Classic Flexible Galvanised Steel Edging Top of steel edge should be flush with height of mowed turf Installer must install edging as per maufacturer's instuctions

metal spikes are part of main steel edge structure

1 Steel Edging Detail 002 Scale 1:10 @ A1

NOTES

AMENDMENTS


DATE

NOTES


REV.

All dimensions to be set out by contractor on site and confirmed by landscape architect prior to construction. Do not scale from drawing. Any discrepancies to be referred to landscape architect.

ltem			Month					
Planted areas: planter boxes and inground	0 to 1	1 to 3 3 to 6 6 to 9 9 to 12 and ongoing						
Watering by automated irrigation	Programmed every day for <u>first</u> week		Progran	nmed to every second da	ay			
Watering by hand		Only if needed upon inspection if plant seen to not be doing well.						
Weeding	Once a month. Remove any failed plants and replace with new speciman of same species							
Mulching	To be maintained and replenished to specified depth of 75mm							
Fertilizing	once a month							
Pest Control	Once a fort	night		once a mor	ith			
Plant Stakes	Remove ties afte	r 3 months		Remove stakes afte	r 6 months			
ltem			Month					
Turfed area : Sir Walter Buffalo 'Sapphire' Grass	0 to 1	1 to 3	3 to 6	6 to 9	9 to 12 and ongoing			
Watering by automated irrigation	Programmed every day for <u>two</u> weeks	 Every 3 Days Once a week during Autumn and Spring and twice a week during Winter and Summer 						
Weeding	Every month							
Fertilizing	Apply fertilizer low in nitrogen content twice a year in Summer and Autumn							

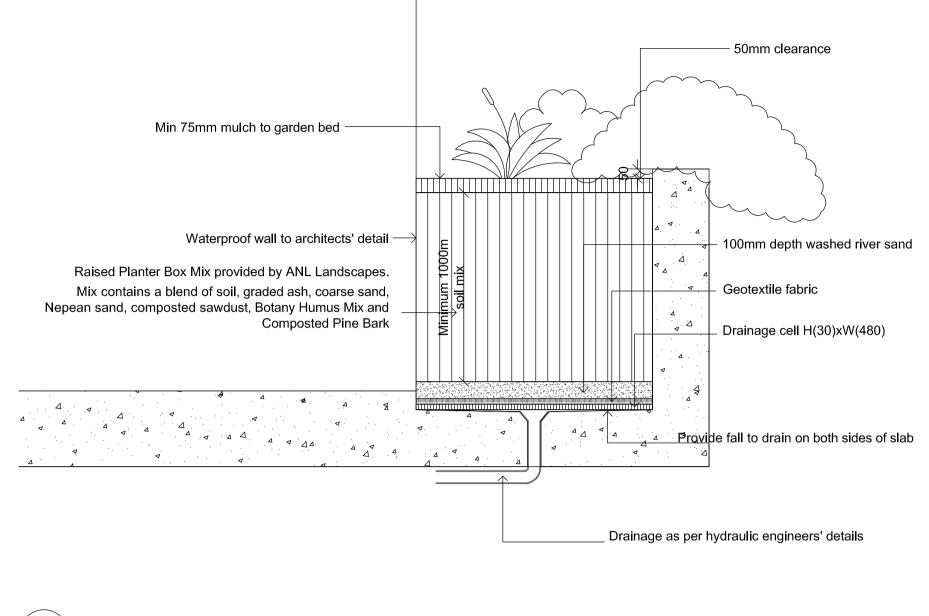

2 Typical Planting Above Slab Detail 002 Scale 1:20 @ A1

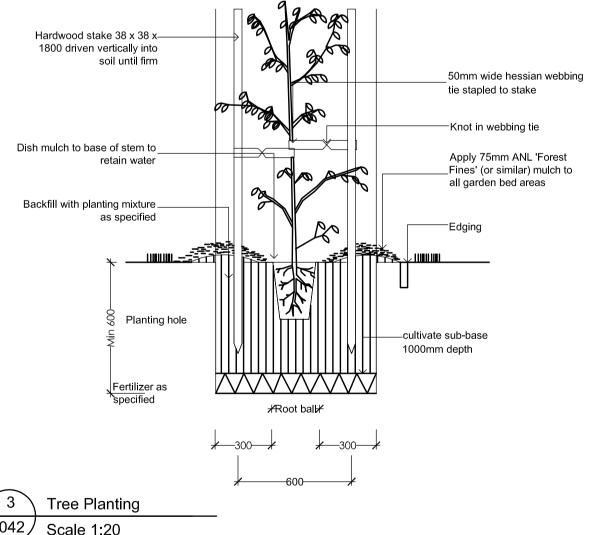

3 042 Scale 1:20

> PROJECT 160-178 Stoney Creek Rd **Beverly Hills**

Elysium Design Landscape Architecture | Garden Design 33 Bernard Road, Padstow Heights 0410 643 685 cjabbour23@hotmail.com

DRAWING Preliminary Landscape Details for DA

